Evansville Fire Department Station 16 Renovations

Evansville Fire Department Station 16 2801 Washington Avenue Evansville, Indiana 47714

IFB - 011 - 01 - 2024

ARCHITECT / ENGINEER:




www.remedydesignllc.com

Indiana Office: P.O. Box 864, Newburgh, IN 47629 (812) 453 - 9034

Illinois Office: P.O. Box 133, Marion, IL 62959 (618) 926 - 4578

CONSULTING ENGINEER:

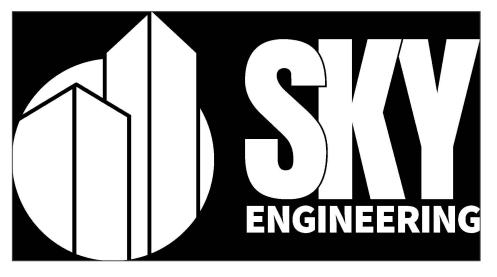

Owensboro Office: 2625 Frederica Drive - Suite #1b Owensboro, KY 42301 (270) 784 - 0722

www.skyengineeringmep.com

Owner:

Evansville, Indiana 47708

City of Evansville Purchasing Department Dachenae Streeter, Director of Purchasing 1 NW Martin Luther King, Jr. Blvd., Rm. 323 Evansville, Indiana 47708

Evansville Fire Department Tony Knight, Fire Chief 550 S.E. Eighth Street Evansville, Indiana 47713

EFD Facilities Management: John Hogg, Transition Manager Dustin Cline, Facilities Manager



Tony Knight, Fire Chief

City of Evansville Board of Public Works 1 NW Martin Luther King, Jr. Blvd., Rm. 321

Jarrod Brown, Deputy Chief - Logistics & Finance


Scope of Work

The work of this project is to convert the existing single dormitory space into multiple private dormitories, expand the existing fitness area, relocate the baby box, provide services for a new dryer unit (unit by Owner), and modify the Battalion Chief's toilet room to add a corner shower unit.


EFD Station 16 Evansville, Indiana

Area Location Plan Not to Scale




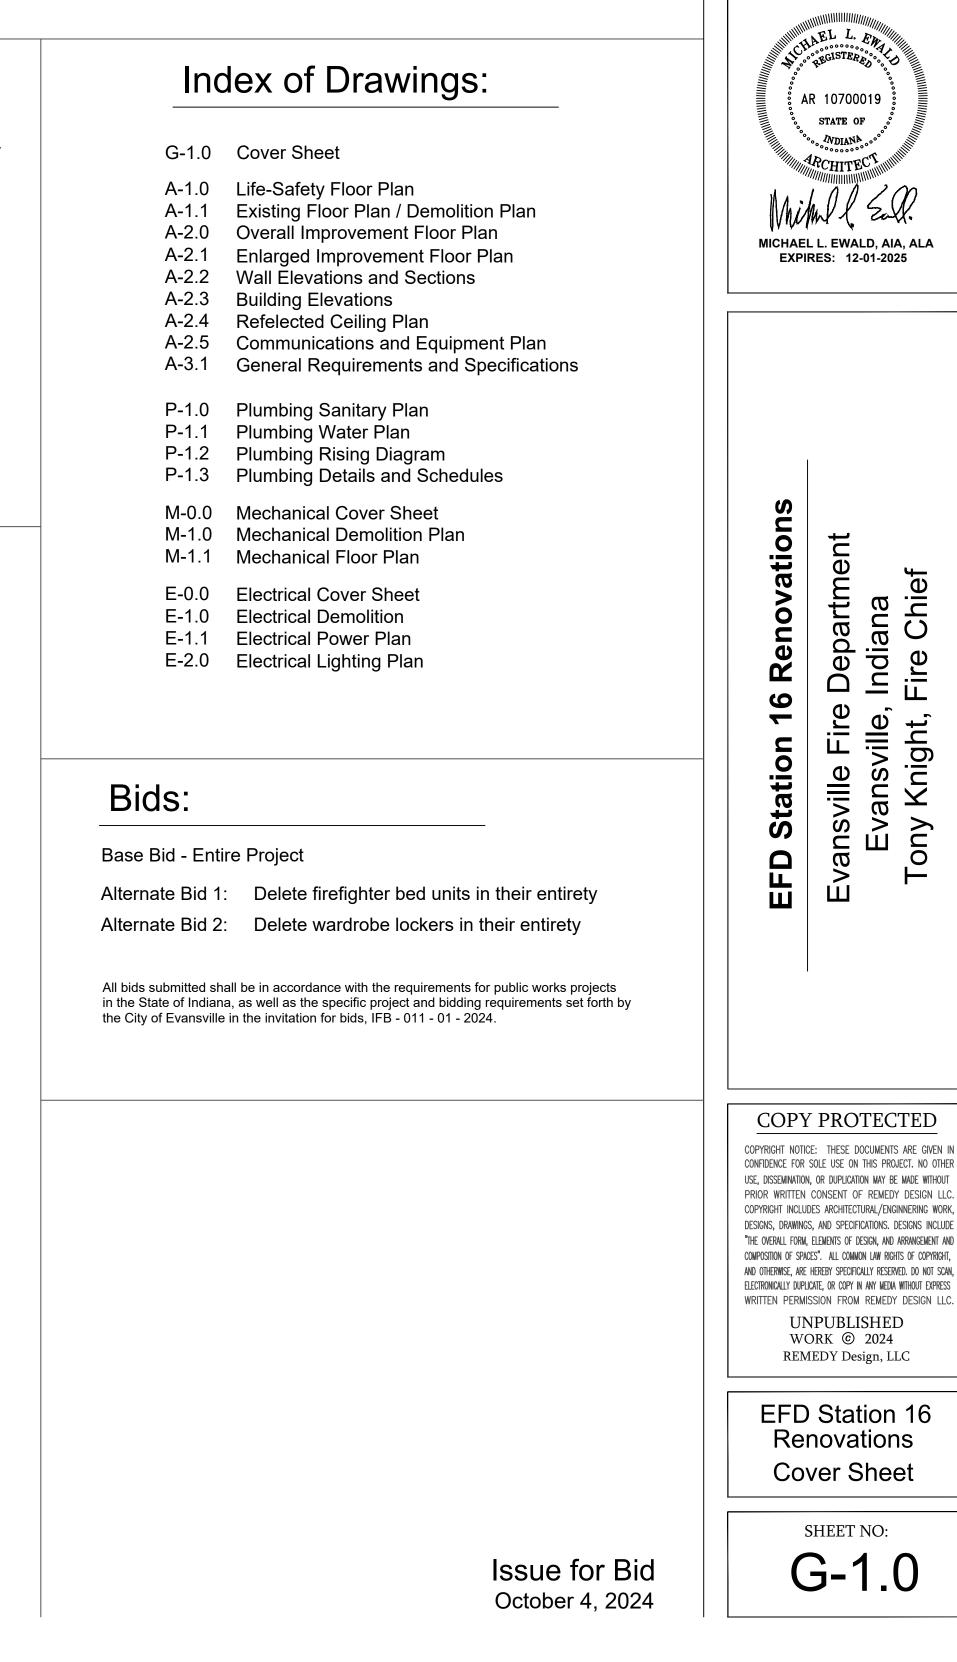


- the nearest adjacent perpendicular wall, unless noted otherwise.
- existing finishes to remain. Replace or repair any damage.
- emergency calls. Isolate service disruptions and work to the designated work areas only.
- extent possible.
- and/or Engineer of any discrepancies.
- communication devices, from damage during the project.
- needed, it is the responsibility of the contractor to provide additional use by workers on the site.
- in accordance with printed instructions, with 120v. outlet, alarm,

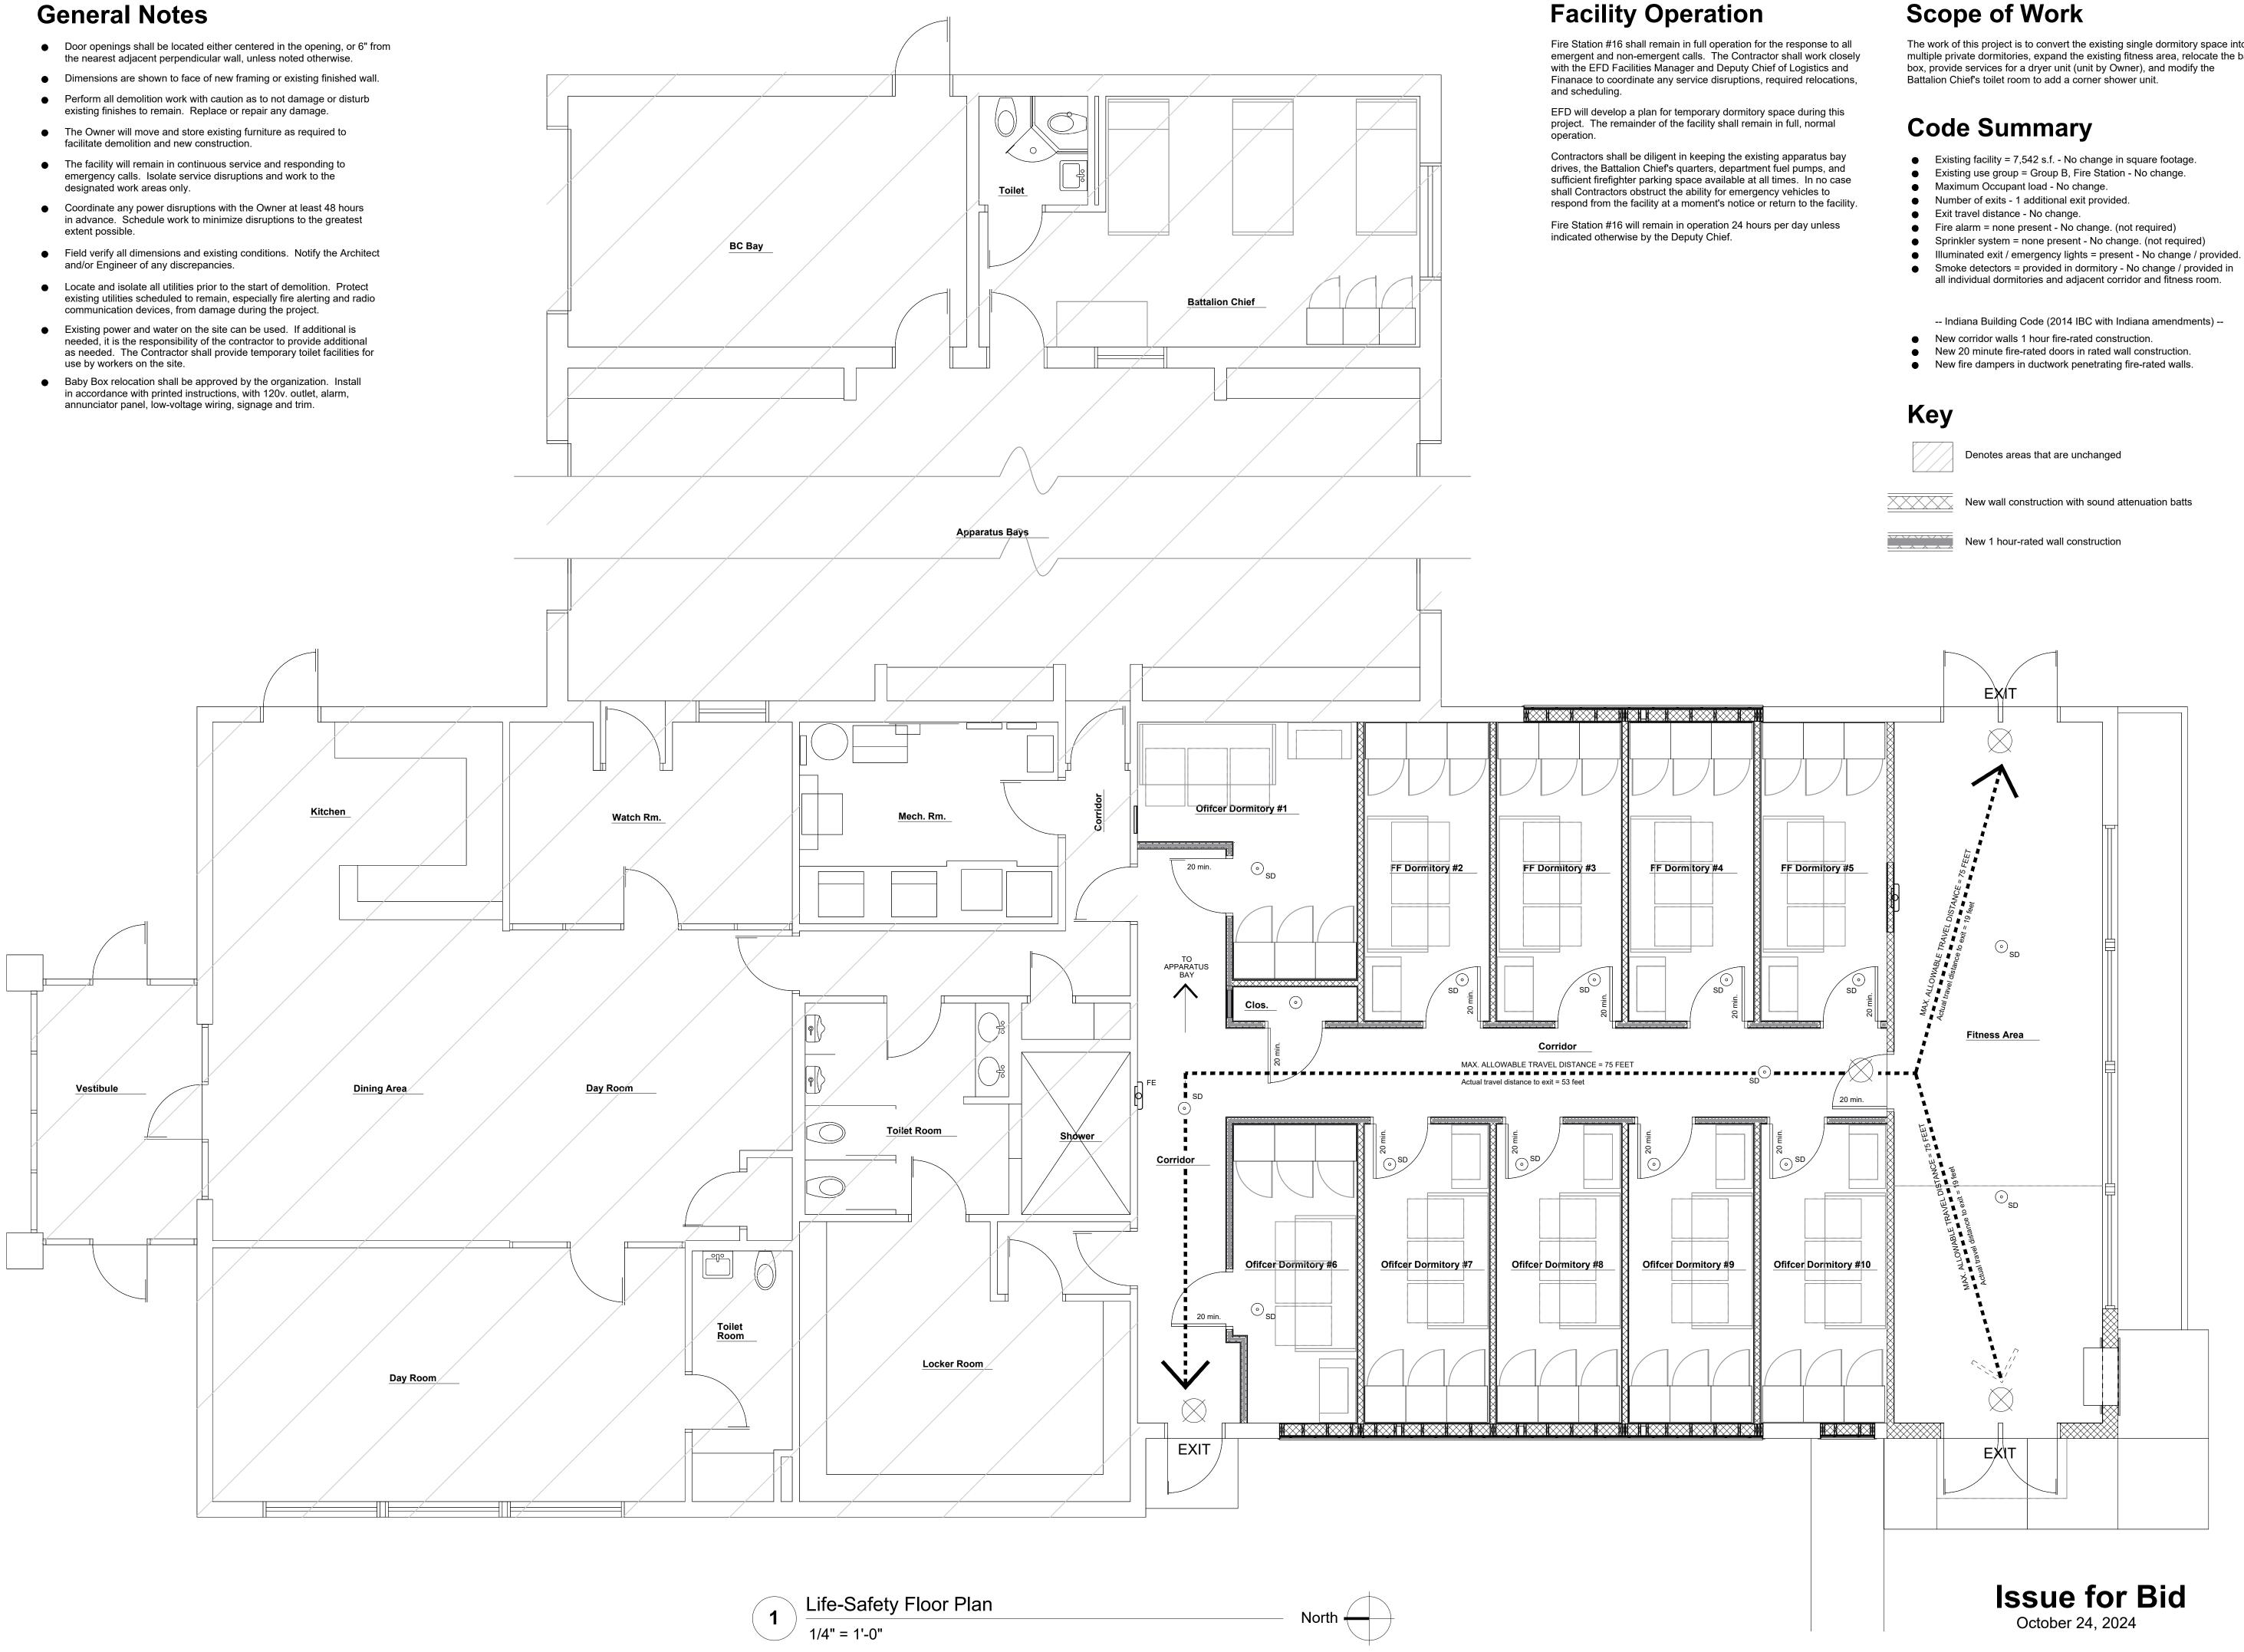




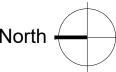


The work of this project is to convert the existing single dormitory space into multiple private dormitories, expand the existing fitness area, relocate the baby box, provide services for a dryer unit (unit by Owner), and modify the

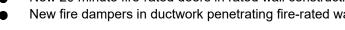

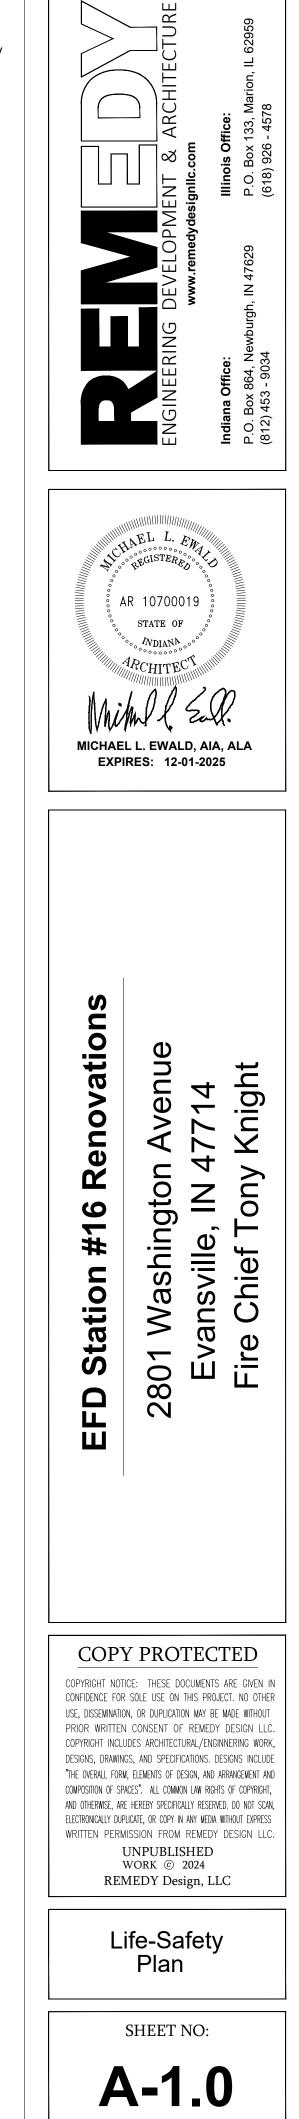

- Perform all demolition work with caution as to not damage or disturb existing finishes to remain. Replace or repair any damage.
- The Owner will move and store existing furniture as required to facilitate demolition and new construction.
- The facility will remain in continuous service and responding to emergency calls. Isolate service disruptions and work to the designated work areas only.
- Coordinate any power disruptions with the Owner at least 48 hours
- Locate and isolate all utilities prior to the start of demolition. Protect communication devices, from damage during the project.
- needed, it is the responsibility of the contractor to provide additional use by workers on the site.

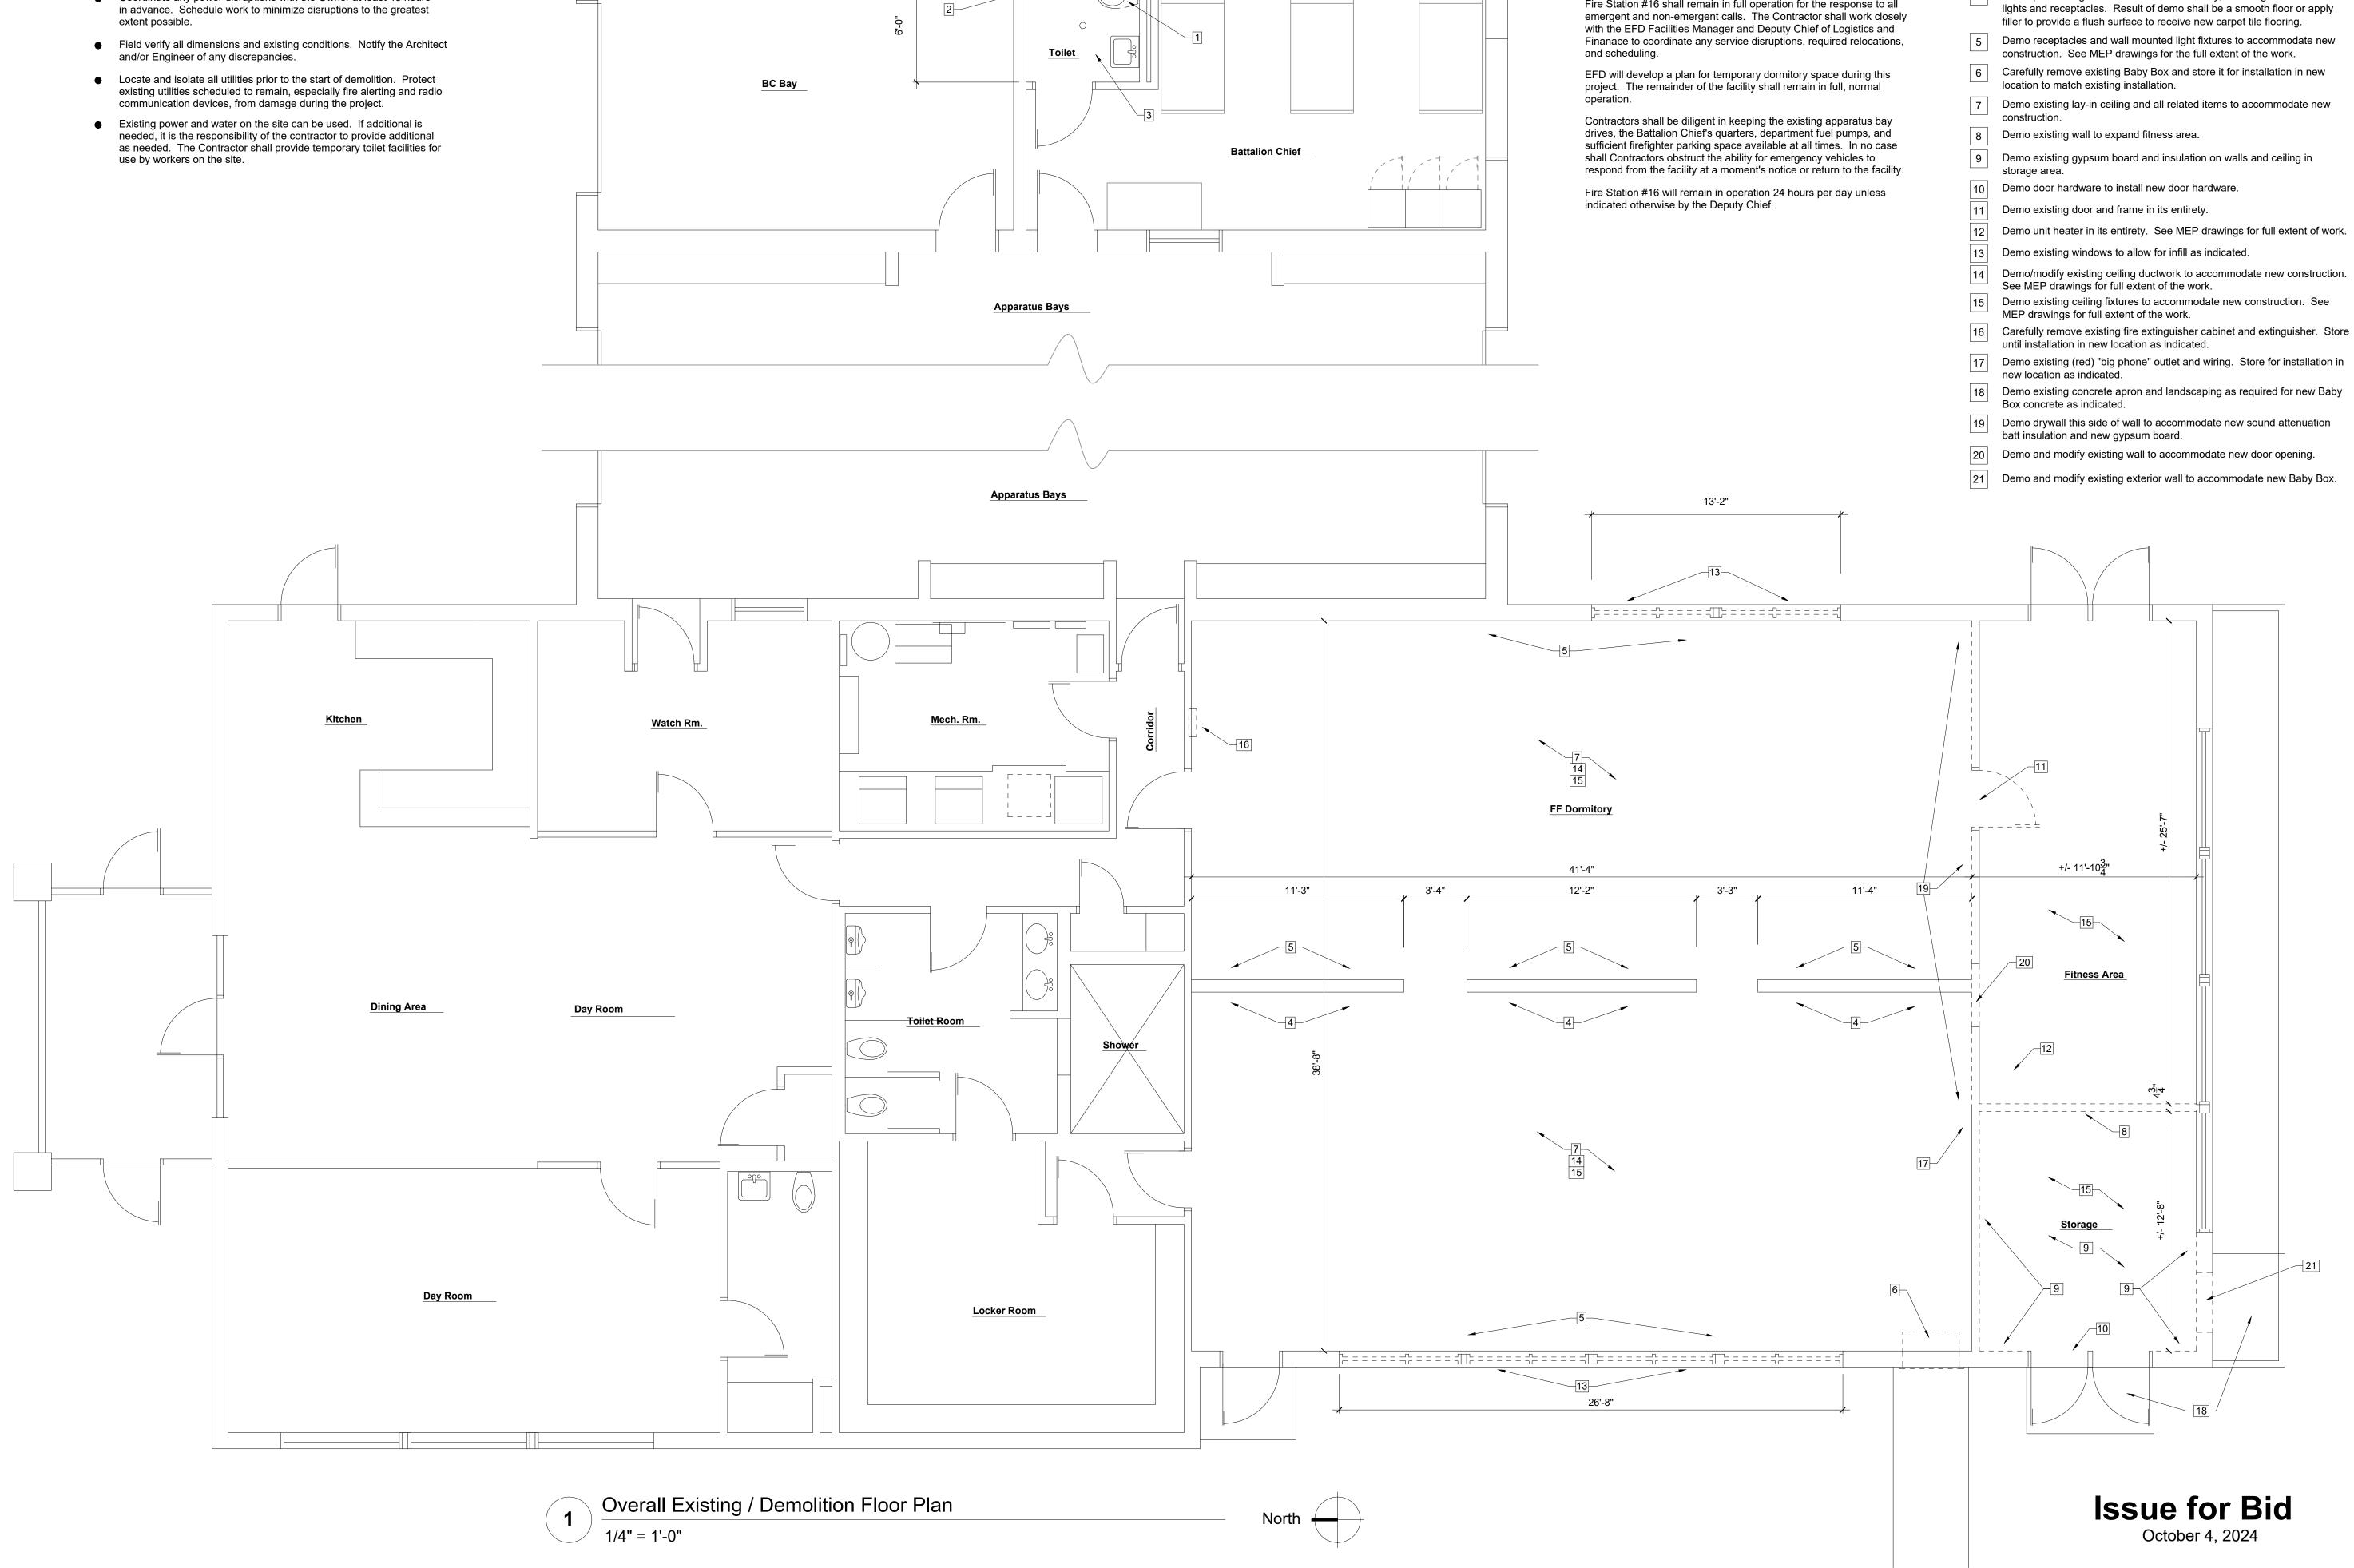

6'-0"




Scope of Work

The work of this project is to convert the existing single dormitory space into multiple private dormitories, expand the existing fitness area, relocate the baby box, provide services for a new dryer unit (unit by Owner), and modify the Battalion Chief's toilet room to add a corner shower unit.

Facility Operation

Fire Station #16 shall remain in full operation for the response to all

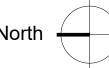


Reference Notes

1 Demo existing water closet to accommodate new shower. See MEP drawings for full extent of the work.

- 2 Demo existing flooring and concrete to accommodate new water closet, new shower and related plumbing. See MEP drawings for full extent of the work.
- 3 New plumbing and electrical work to accommodate new toilet room layout. See MEP drawings for full extent of the work.
- 4 Demo partial height CMU walls in their entirety, including wall mounted lights and receptacles. Result of demo shall be a smooth floor or apply


- 12 Demo unit heater in its entirety. See MEP drawings for full extent of work.
- Demo/modify existing ceiling ductwork to accommodate new construction.
- 15 Demo existing ceiling fixtures to accommodate new construction. See
- 17Demo existing (red) "big phone" outlet and wiring. Store for installation in
- 18 Demo existing concrete apron and landscaping as required for new Baby
- 19 Demo drywall this side of wall to accommodate new sound attenuation

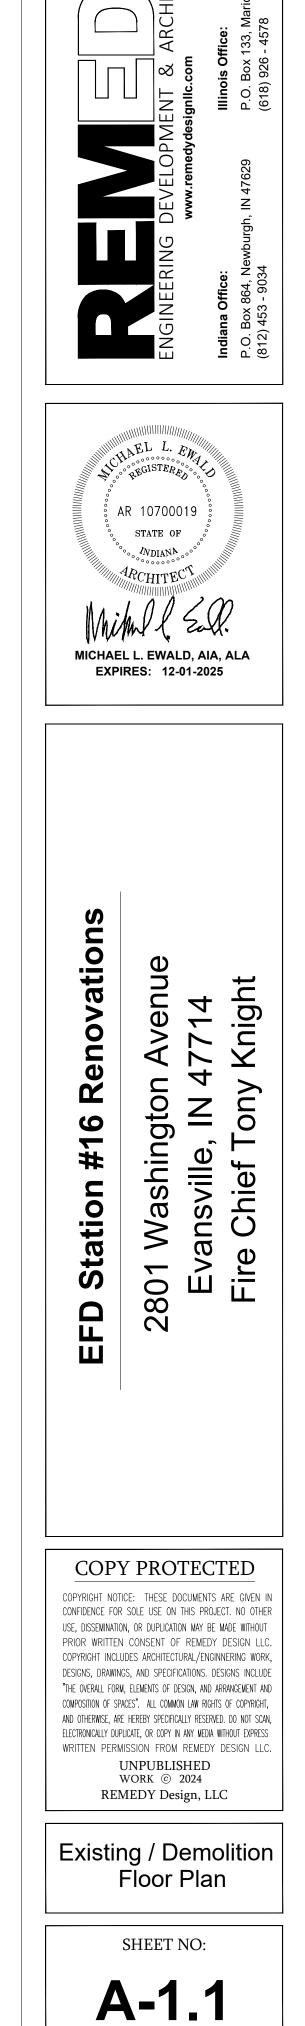


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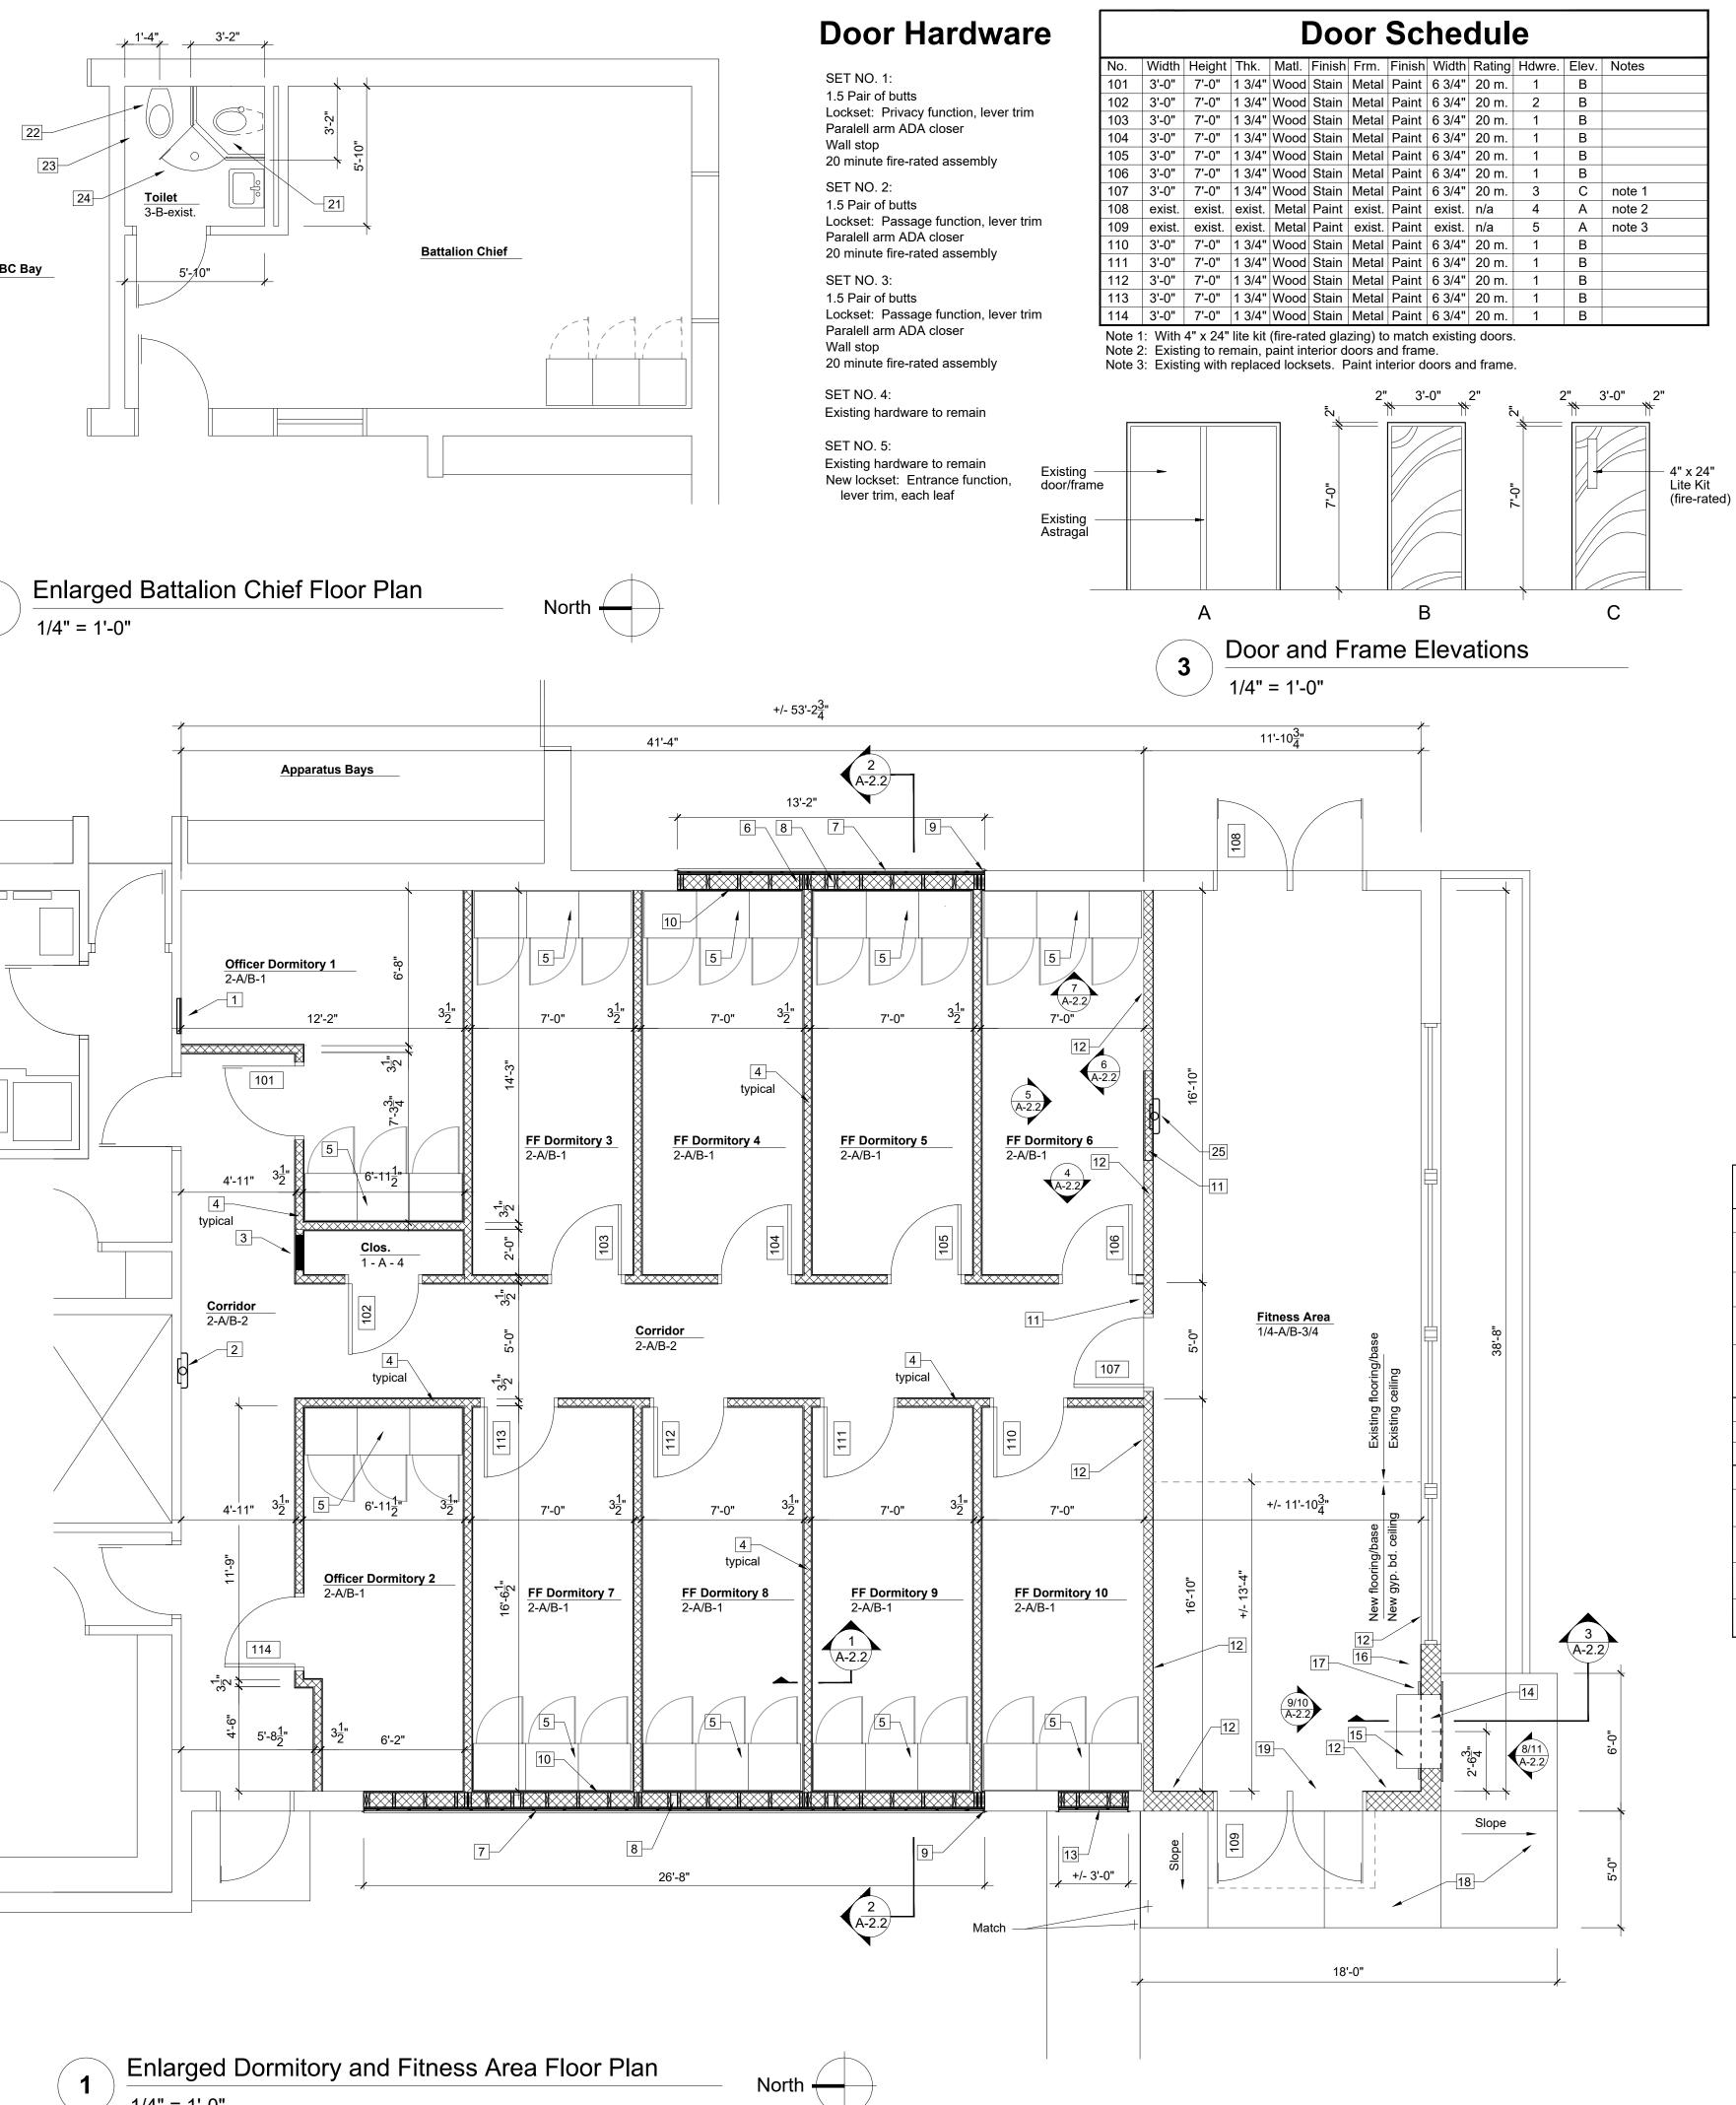
- emergency calls. Isolate service disruptions and work to the

- needed, it is the responsibility of the contractor to provide additional use by workers on the site.
- in accordance with printed instructions, with 120v. outlet, alarm, annunciator panel, low-voltage wiring, signage and trim.




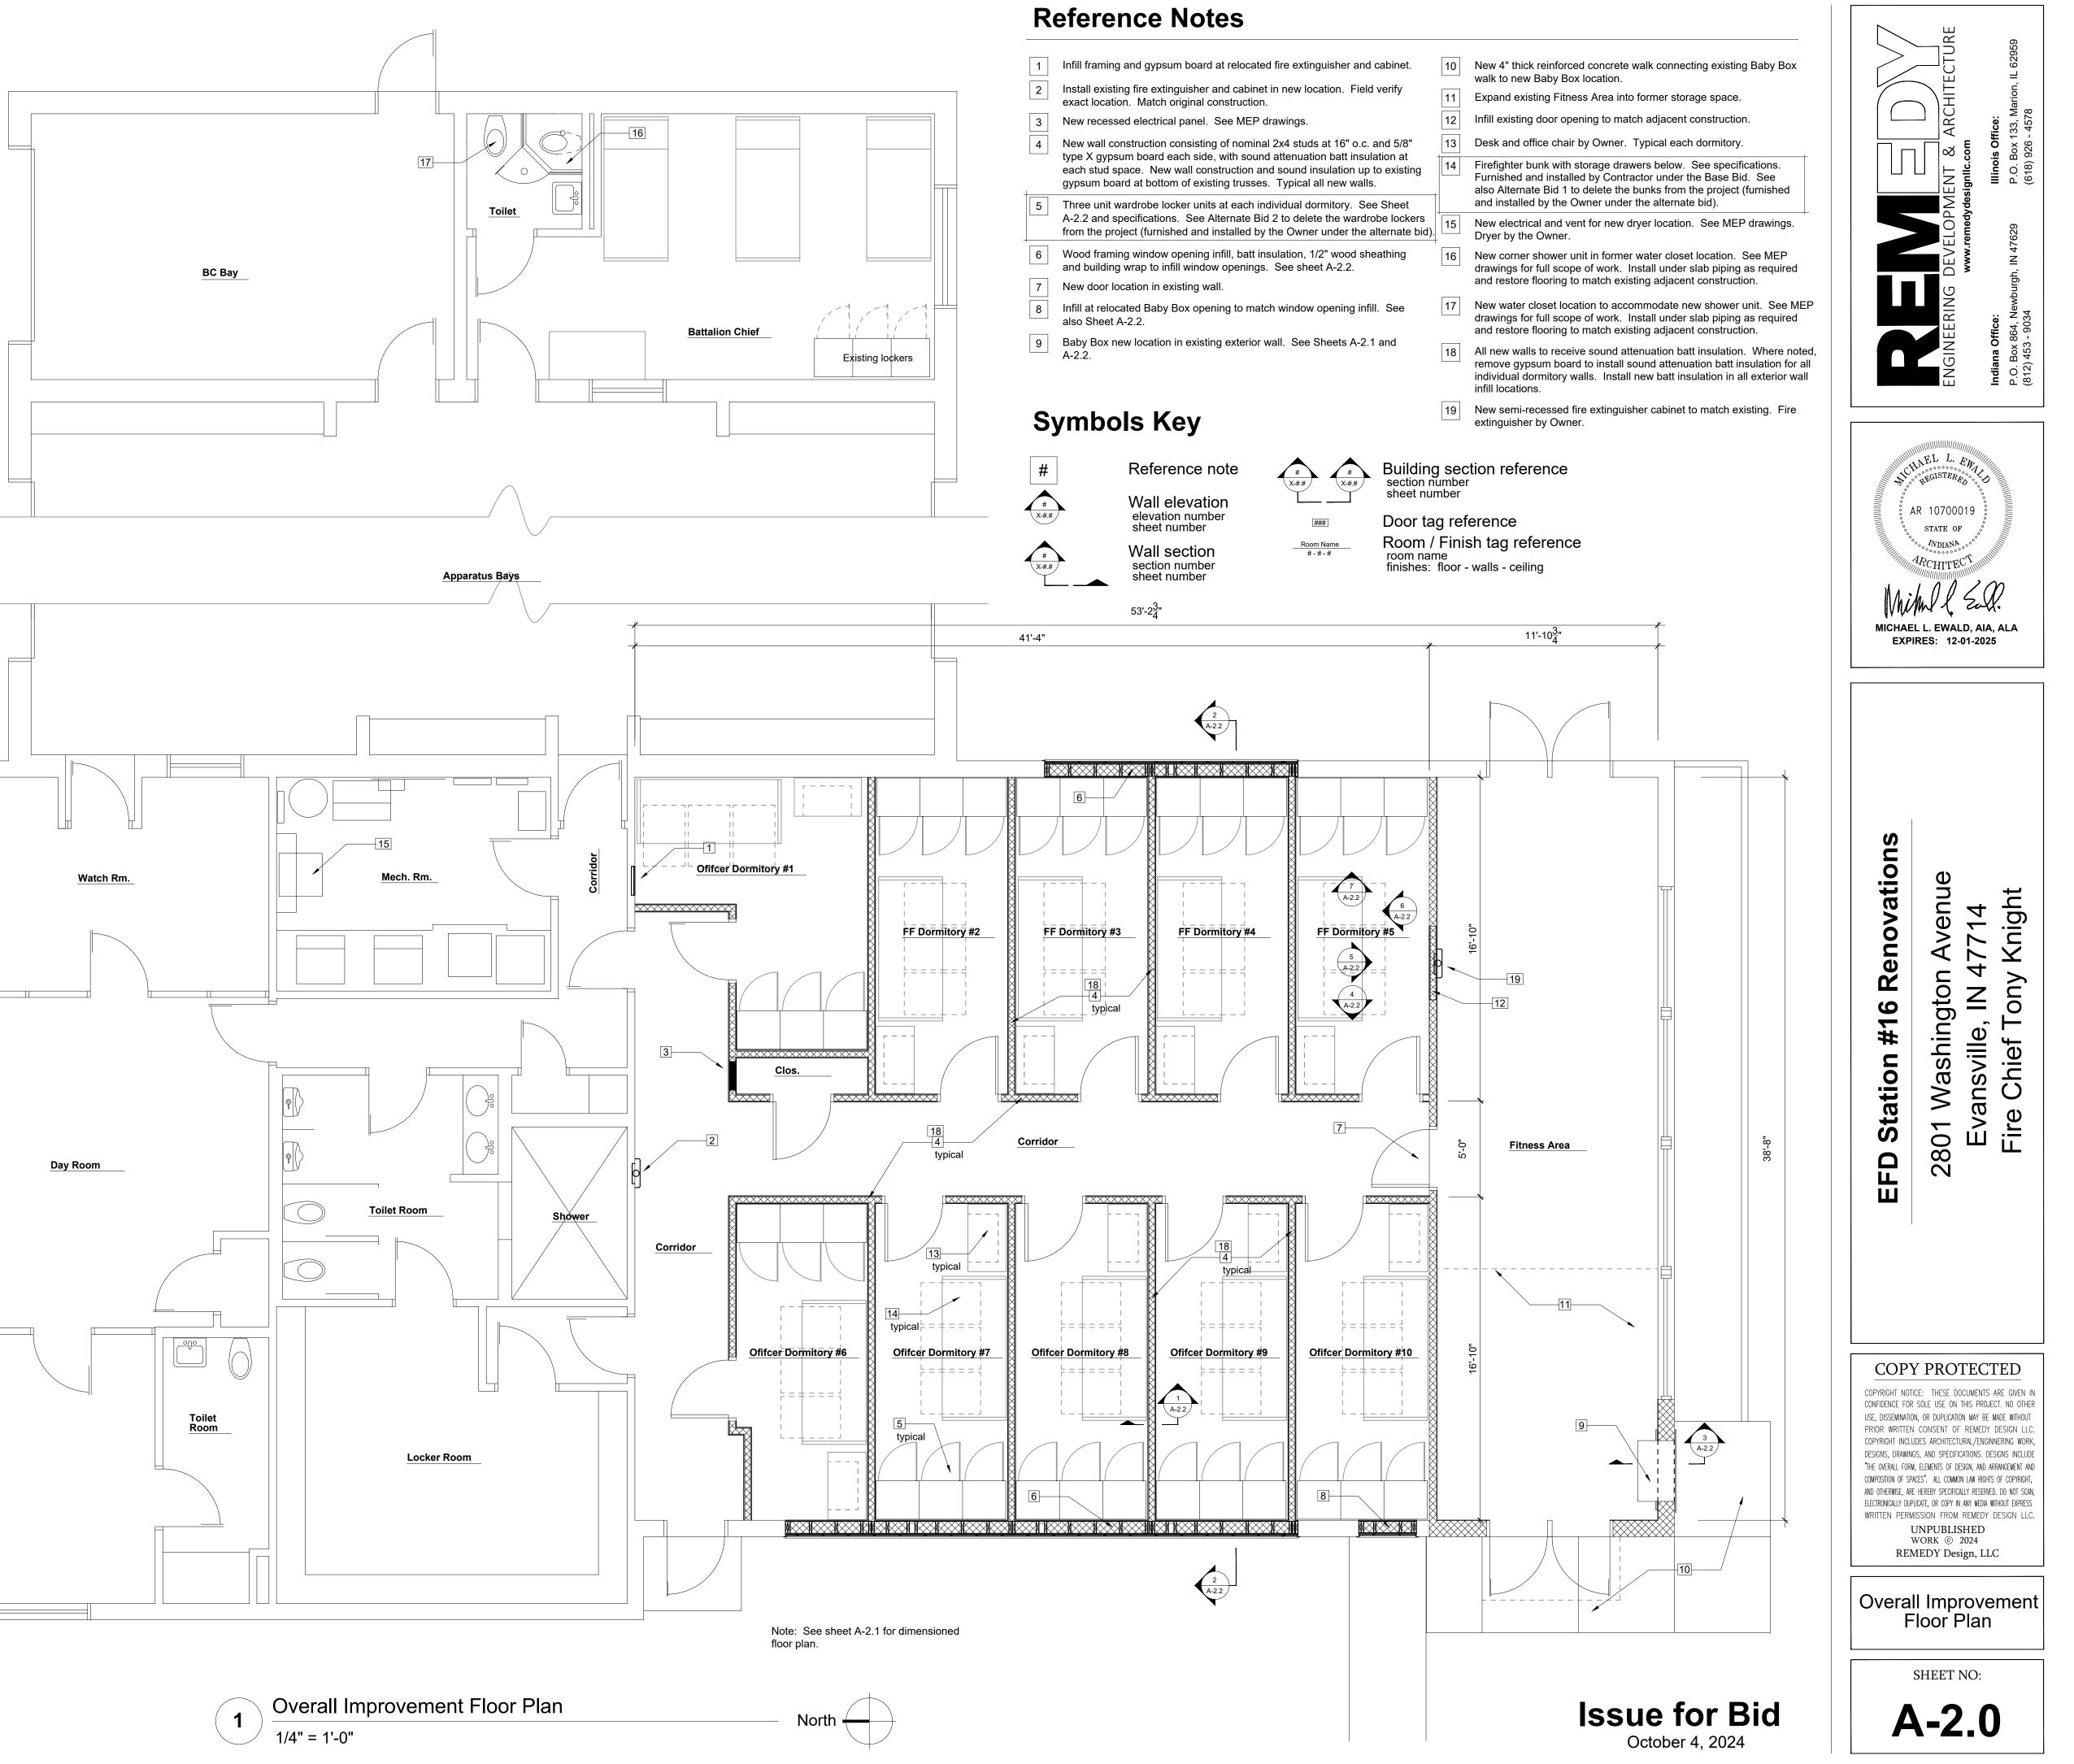

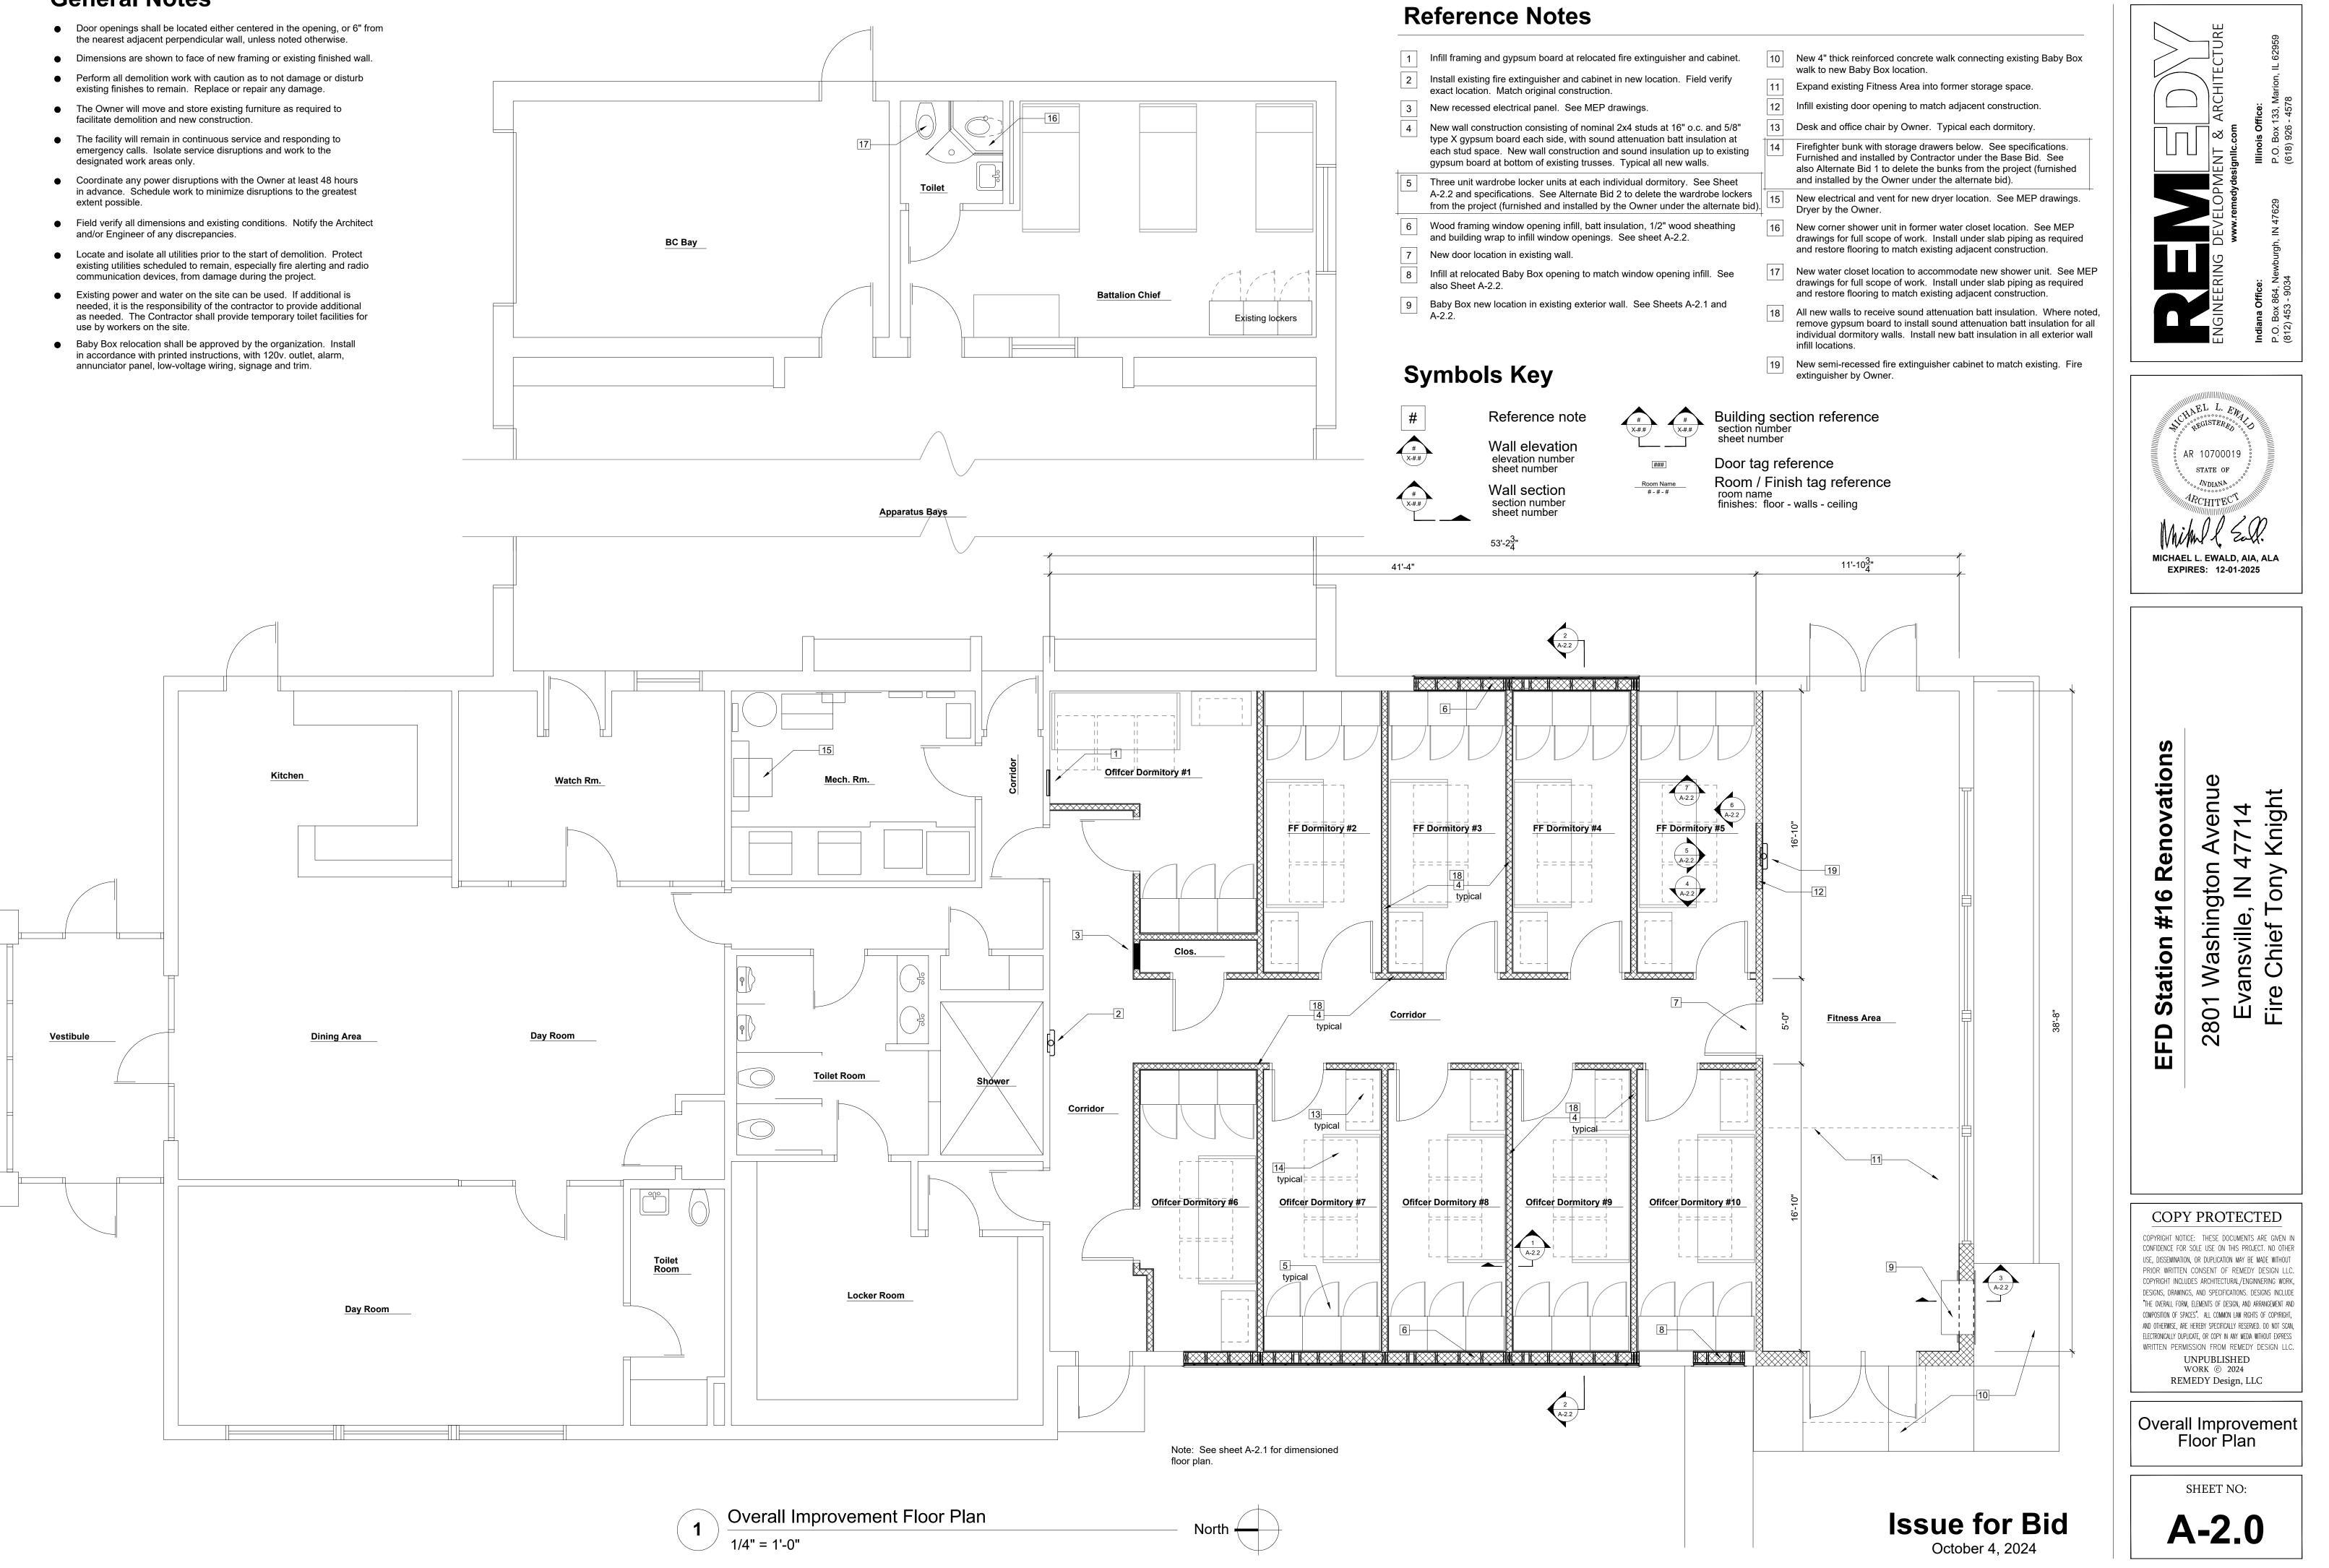- Door openings shall be located either centered in the opening, or 6" from
- Perform all demolition work with caution as to not damage or disturb
- The facility will remain in continuous service and responding to
- designated work areas only. • Coordinate any power disruptions with the Owner at least 48 hours
- extent possible.
- and/or Engineer of any discrepancies.
- communication devices, from damage during the project.
- needed, it is the responsibility of the contractor to provide additional use by workers on the site.
- Baby Box relocation shall be approved by the organization. Install in accordance with printed instructions, with 120v. outlet, alarm, annunciator panel, low-voltage wiring, signage and trim.





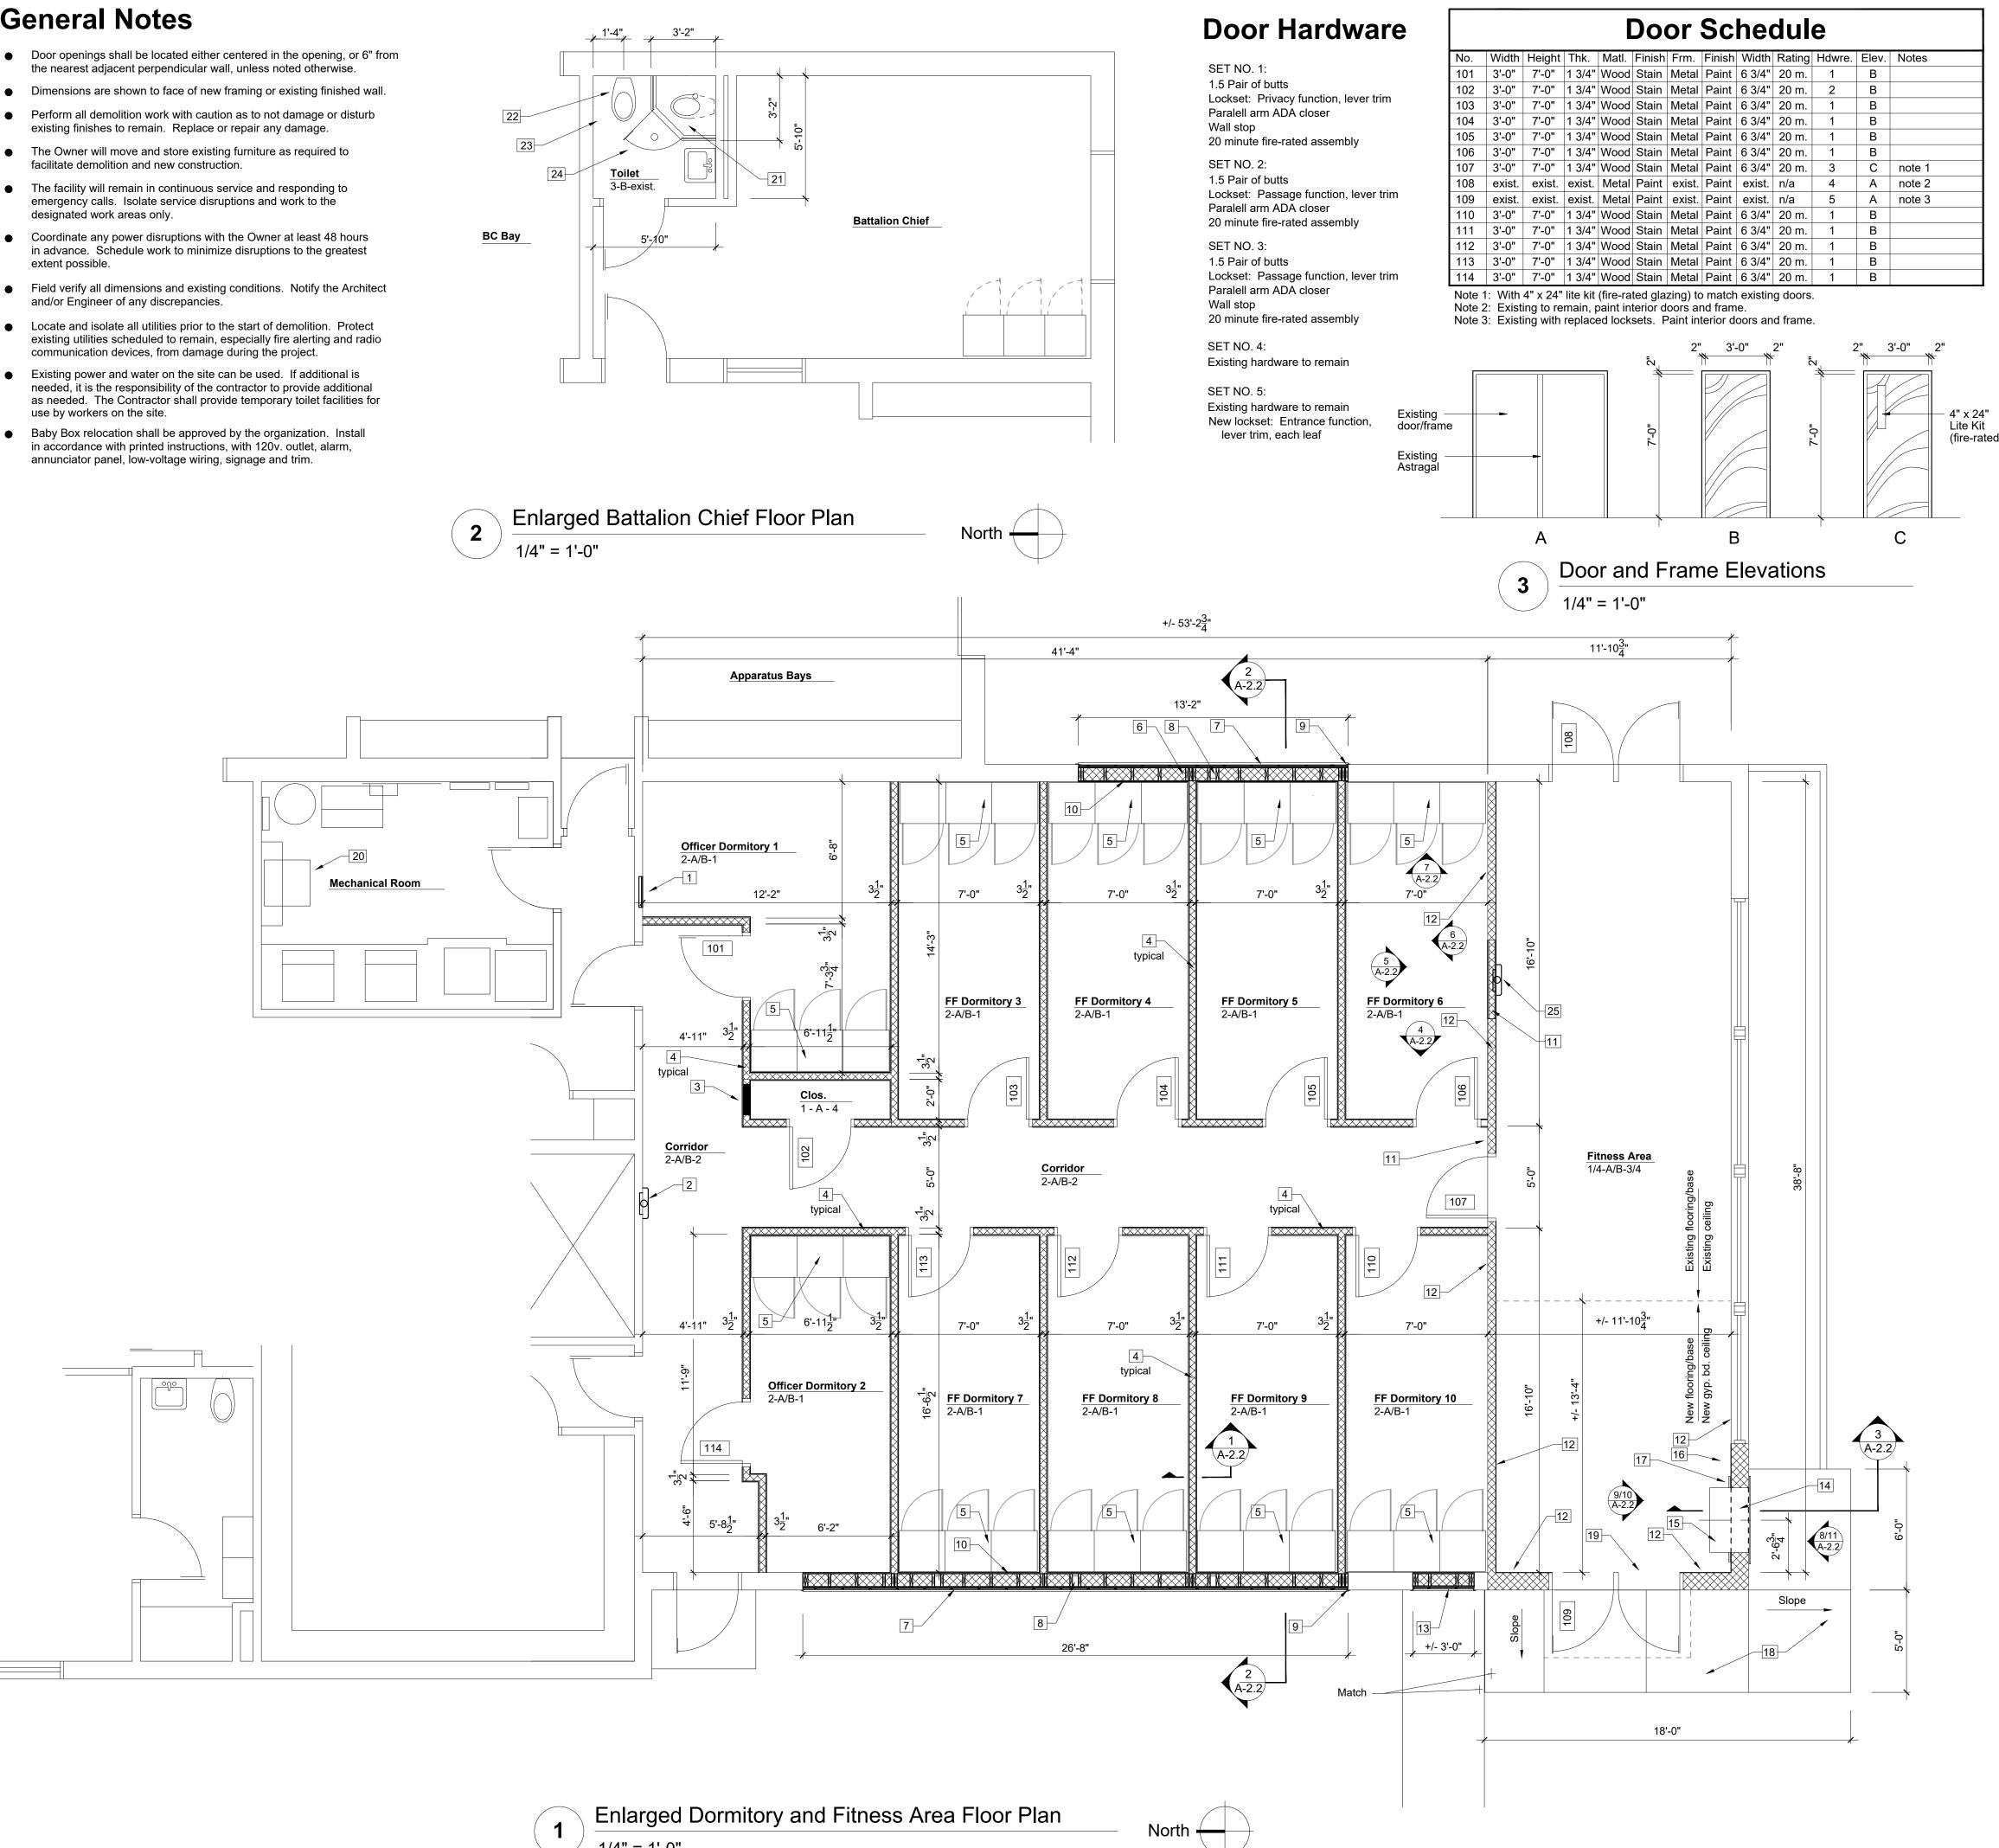



Keyed Improvement Notes

1 Infill framing and gypsum board at relocated fire extinguisher and cabinet. 2 Install existing fire extinguisher and cabinet in new location. Field verify

exact location. Match original construction. 131 New recessed electrical panel. See MEP drawings.

- New wall construction consisting of nominal 2x4 studs at 16" o.c. and 5/8" 4 type X gypsum board each side, with sound attenuation batt insulation at each stud space. New wall construction and sound insulation up to existing gypsum board at bottom of existing trusses.
- 5 Three unit wardrobe locker units at each individual dormitory. See also sheet A-2.2 and specifications. See alternate bid 2 to delete wardrobe lockers in their entirety (lockers furnished and installed by the Owner under alternate).
- 6 Wood framing window opening infill, batt insulation, 1/2" wood sheathing and building wrap to infill window openings.
- 7 Vertical metal siding at exterior face of infilled window openings. Color by Owner. See specifications.

8 Existing structural framing to remain.

- Metal trim and sealant at entire window infill perimeter. Caulk weather-tight. Field verify exact requirements.
- New gypsum board infill at interior face of window infill openings. Install 10 flush with existing gypsum board.
- Framing, sound attenuation batt insulation and type X gypsum board infill for existing door opening.
- 12 Install sound attenuation batts in existing wall framing and install new 5/8" type X gypsum board this side of wall.
- 13 Infill for removed Baby Box location similar to window opening infill. See notes 7, 9 and 10.
- Re-install existing Baby Box in new location. Provide a 38" wide x 34" high 14 framed rough opening with sill at 30" above the sidewalk elevation. Install a 3 1/2" x 3 1/2" x 3/8" steel lintel, painted, with 8" bearing each end. Install and anchor Baby Box in new location to match previous installation. Install associated trim, alarms and signage to match previous installation.
- 15 120v. duplex receptacle for Baby Box power. See Communications and Equipment Plan and MEP drawings.
- 16 Relocated existing Baby Box alarm annunciator panel. Match previous installation.
- 17 Wood trim as required to conceal insulation and caulk sealant at Baby Box rough opening interior perimeter. Field verify. Paint trim to match wall.
- 18 New 4" thick concrete walk with 6x6 w1.4 x w1.4 welded wire fabric reinforcement over minimum 4" compacted aggregate base. Match elevation at existing walk and 1/4" below finish floor at door #109. Slope walk 1/8" per foot to drain away from building. Field verify exact elevations. Provide 1/2" expansion joint and sealant at all vertical surfaces and at all dissimilar surfaces.
- 19 Modify existing door #109 hardware as indicated.
- 20 New dryer location. Dryer by Owner. See MEP drawings for electrical and dryer vent installation. Field verify exact locations.
- 21 New corner shower unit. See MEP drawings for full extent of the work. 22 New water closet in new location. See MEP drawings for full extent of
- the work.
- 23 Relocate existing toilet paper dispenser for new water closet location.
- 124 Install new under slab piping and replace concrete slab and tile floor to match existing construction as closely as possible.
- New semi-recessed fire extinguisher cabinet in infilled door opening. Match 25 existing fire extinguisher cabinet. Field verify. Extinguisher by Owner.

Room Finish Schedule

FLOORS:

- Existing rubber athletic flooring to remain. New 4" rubber cove base. Color by Owner.
- 2. 2' x 2' carpet tile squares adhered to existing vct flooring, with 4" rubber cove base. Colors / patterns by Owner.
- Quarry tile and grout to match existing as closely as possible, with 4" quarry tile cove base. Color by Owner.
- New rubber athletic flooring over existing concrete slab floor, with transition strip at existing flooring and new 4" rubber cove base throughout entire expanded fitness area. Colors / patterns by Owner.

WALLS:

A. New gypsum board, painted. Color by Owner.

B. Existing gypsum board. Patch and prepare for new paint. Color by Owner. CEILINGS:

- New 2' x 2' suspended acoustical tile and grid ceiling. White color. Height: 8'-3" A.F.F.
- New 2' x 2' suspended acoustical tile and grid ceiling. White color. Height: 8'-0" A.F.F.
- New gypsum board ceiling to match adjacent existing gypsum board ceiling, painted. White color. Height: +/- 9'-11 3/4" A.F.F.
- Existing gypsum board to remain, patch and prepare for new paint. White color. Height: +/- 9'-11 3/4" A.F.F.


Symbols Key



(# (X-#.#)

Reference note

Wall elevation sheet number Wall section section number

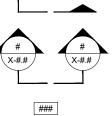

- Room Name # X #
- elevation number
- sheet number Building section reference section number sheet number

Door tag reference door number

Room / Finish tag reference room name finishes: floor - walls - ceiling



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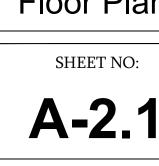
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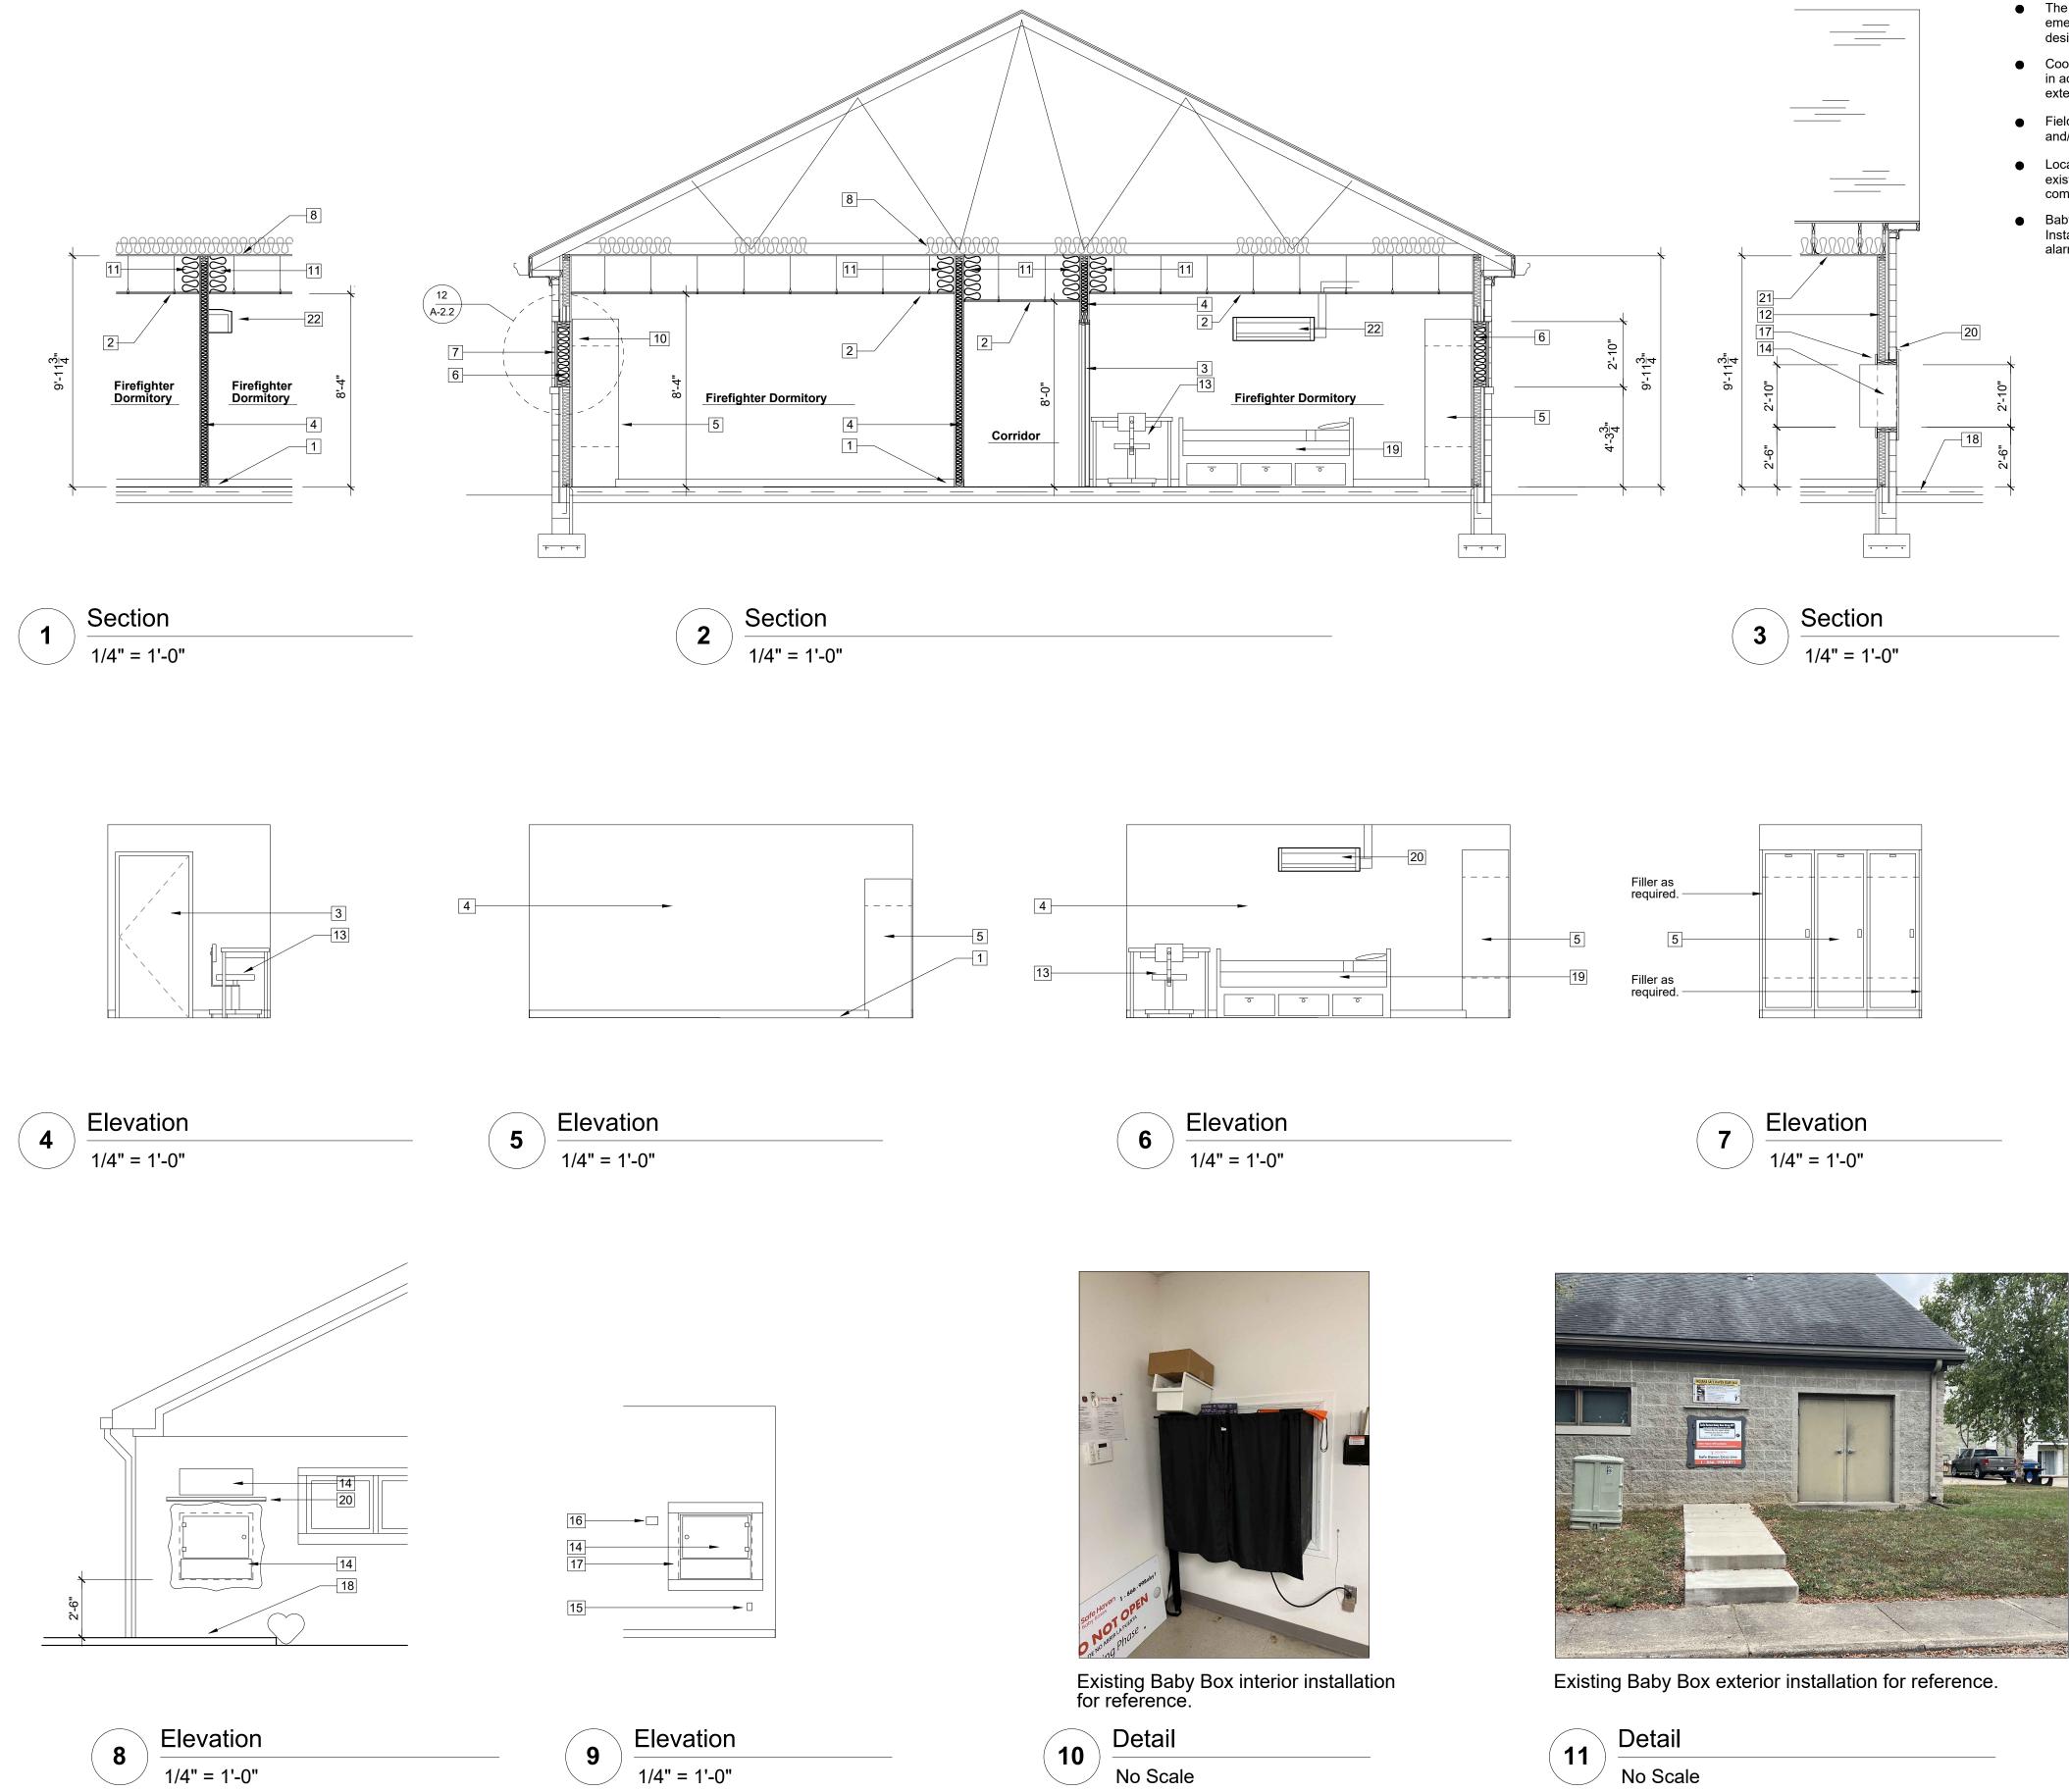
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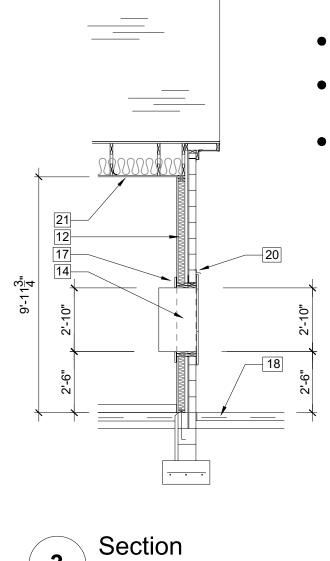


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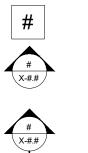
- Perform all demolition work with caution as to not damage or disturb existing finishes to remain. Replace or repair any damage.
- The Owner will move and store existing furniture as required to facilitate demolition and new construction.
- The facility will remain in continuous service and responding to emergency calls. Isolate service disruptions and work to the designated work areas only.
- Coordinate any power disruptions with the Owner at least 48 hours in advance. Schedule work to minimize disruptions to the greatest extent possible.
- Field verify all dimensions and existing conditions. Notify the Architect and/or Engineer of any discrepancies.
- Locate and isolate all utilities prior to the start of demolition. Protect existing utilities scheduled to remain, especially fire alerting and radio communication devices, from damage during the project.
- Baby Box relocation shall be approved by Safe Haven Baby Box. Install in accordance with printed instructions, with 120v. outlet, alarm, annunciator panel, low-voltage wiring, signage and trim.




Keyed Improvement Notes

- Prepare existing floor and install new carpet tile flooring and 4" rubber cove base. 2 New 2' x 2' lay-in acoustical tile and grid ceiling. 3 New door and frame in new wall construction. 4 New wall construction consisting of nominal 2x4 studs at 16" o.c. and 5/8" type X gypsum board each side, with sound attenuation batt insulation at each stud space. New wall construction and sound insulation up to existing gypsum board at bottom of existing trusses. Three unit wardrobe locker units at each individual dormitory. See also sheet 5 A-2.2 and specifications. See alternate bid 2 to delete lockers in their entirety. 6 Wood framing window opening infill, batt insulation, 1/2" wood sheathing and building wrap to infill window openings. Vertical metal siding at exterior face of infilled window openings. Color by Owner. See specifications. 8 Existing gypsum board and insulation at bottom chord of truss to remain. 9 Metal trim and sealant at entire window infill perimeter. Caulk weather-tight. Field verify exact requirements. 10 New gypsum board infill at interior face of window infill openings. Install flush with existing gypsum board. 11 12" thickness vertical sound attenuation batt insulation at dormitory walls. Fasten as required to remain in place. Verify installation with ductwork.
- 12 Install sound attenuation batts in existing wall framing and install new 5/8" type X gypsum board this side of wall.
- 13 Desk and office chair by Owner.
- Re-install existing Baby Box in new location. Provide a 38" wide x 34" high framed rough opening with sill at 30" above the sidewalk elevation. Install a 3 1/2" x 3 1/2" x 3/8" steel lintel, painted, with 8" bearing each end. Install and anchor Baby Box in new location to match previous installation. Install associated trim, alarms and signage to match previous installation.
- 15 120v. duplex receptacle for Baby Box power. See Communications and Equipment Plan and MEP drawings.
- 16 Relocated existing Baby Box alarm annunciator panel. Match previous installation.
- [17] Wood trim as required to conceal insulation and caulk sealant at Baby Box rough opening interior perimeter. Field verify. Paint trim to match wall.
- 18
 New 4" thick concrete walk with 6x6 w1.4 x w1.4 welded wire fabric
 reinforcement over minimum 4" compacted aggregate base. Match elevation at existing walk and 1/4" below finish floor at door #109. Slope walk 1/8" per foot to drain away from building. Field verify exact elevations. Provide 1/2" expansion joint and sealant at all vertical surfaces and at all dissimilar surfaces. Provide light broom finish.
- 19Firefighter bed with storage drawers furnished and installed by Contractor and deducted from the project under Alternate Bid 1.
- 20 Relocate existing drip edge to new location or replace with new to match existing installation.
- 21 New 5/8" gypsum board ceiling at former storage space with new R-38 fiberglass insulation with new ceiling construction.
- 22 Ductless HVAC System wall cassette. See MEP drawings. Install in accordance with manufacturer's instructions for access and maintenance.

Symbols Key



Reference note

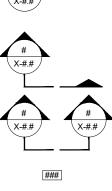

Room Name # - # - #


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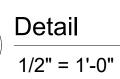
Wall elevation elevation number sheet number

Wall section section number sheet number

Building section reference section number sheet number

Door tag reference Room / Finish tag reference room name finishes: floor - walls - ceiling Magnified Detail sheet number




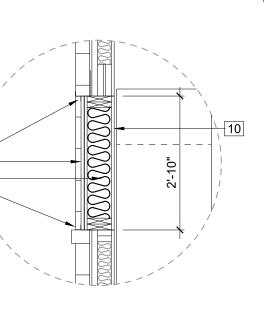

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October 4, 2024



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#16 Renov
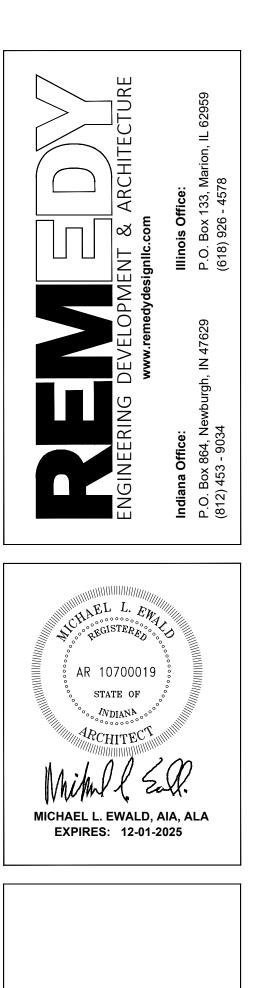
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2801 Washington Aven Evansville, IN 47714 Fire Chief Tony Knigh

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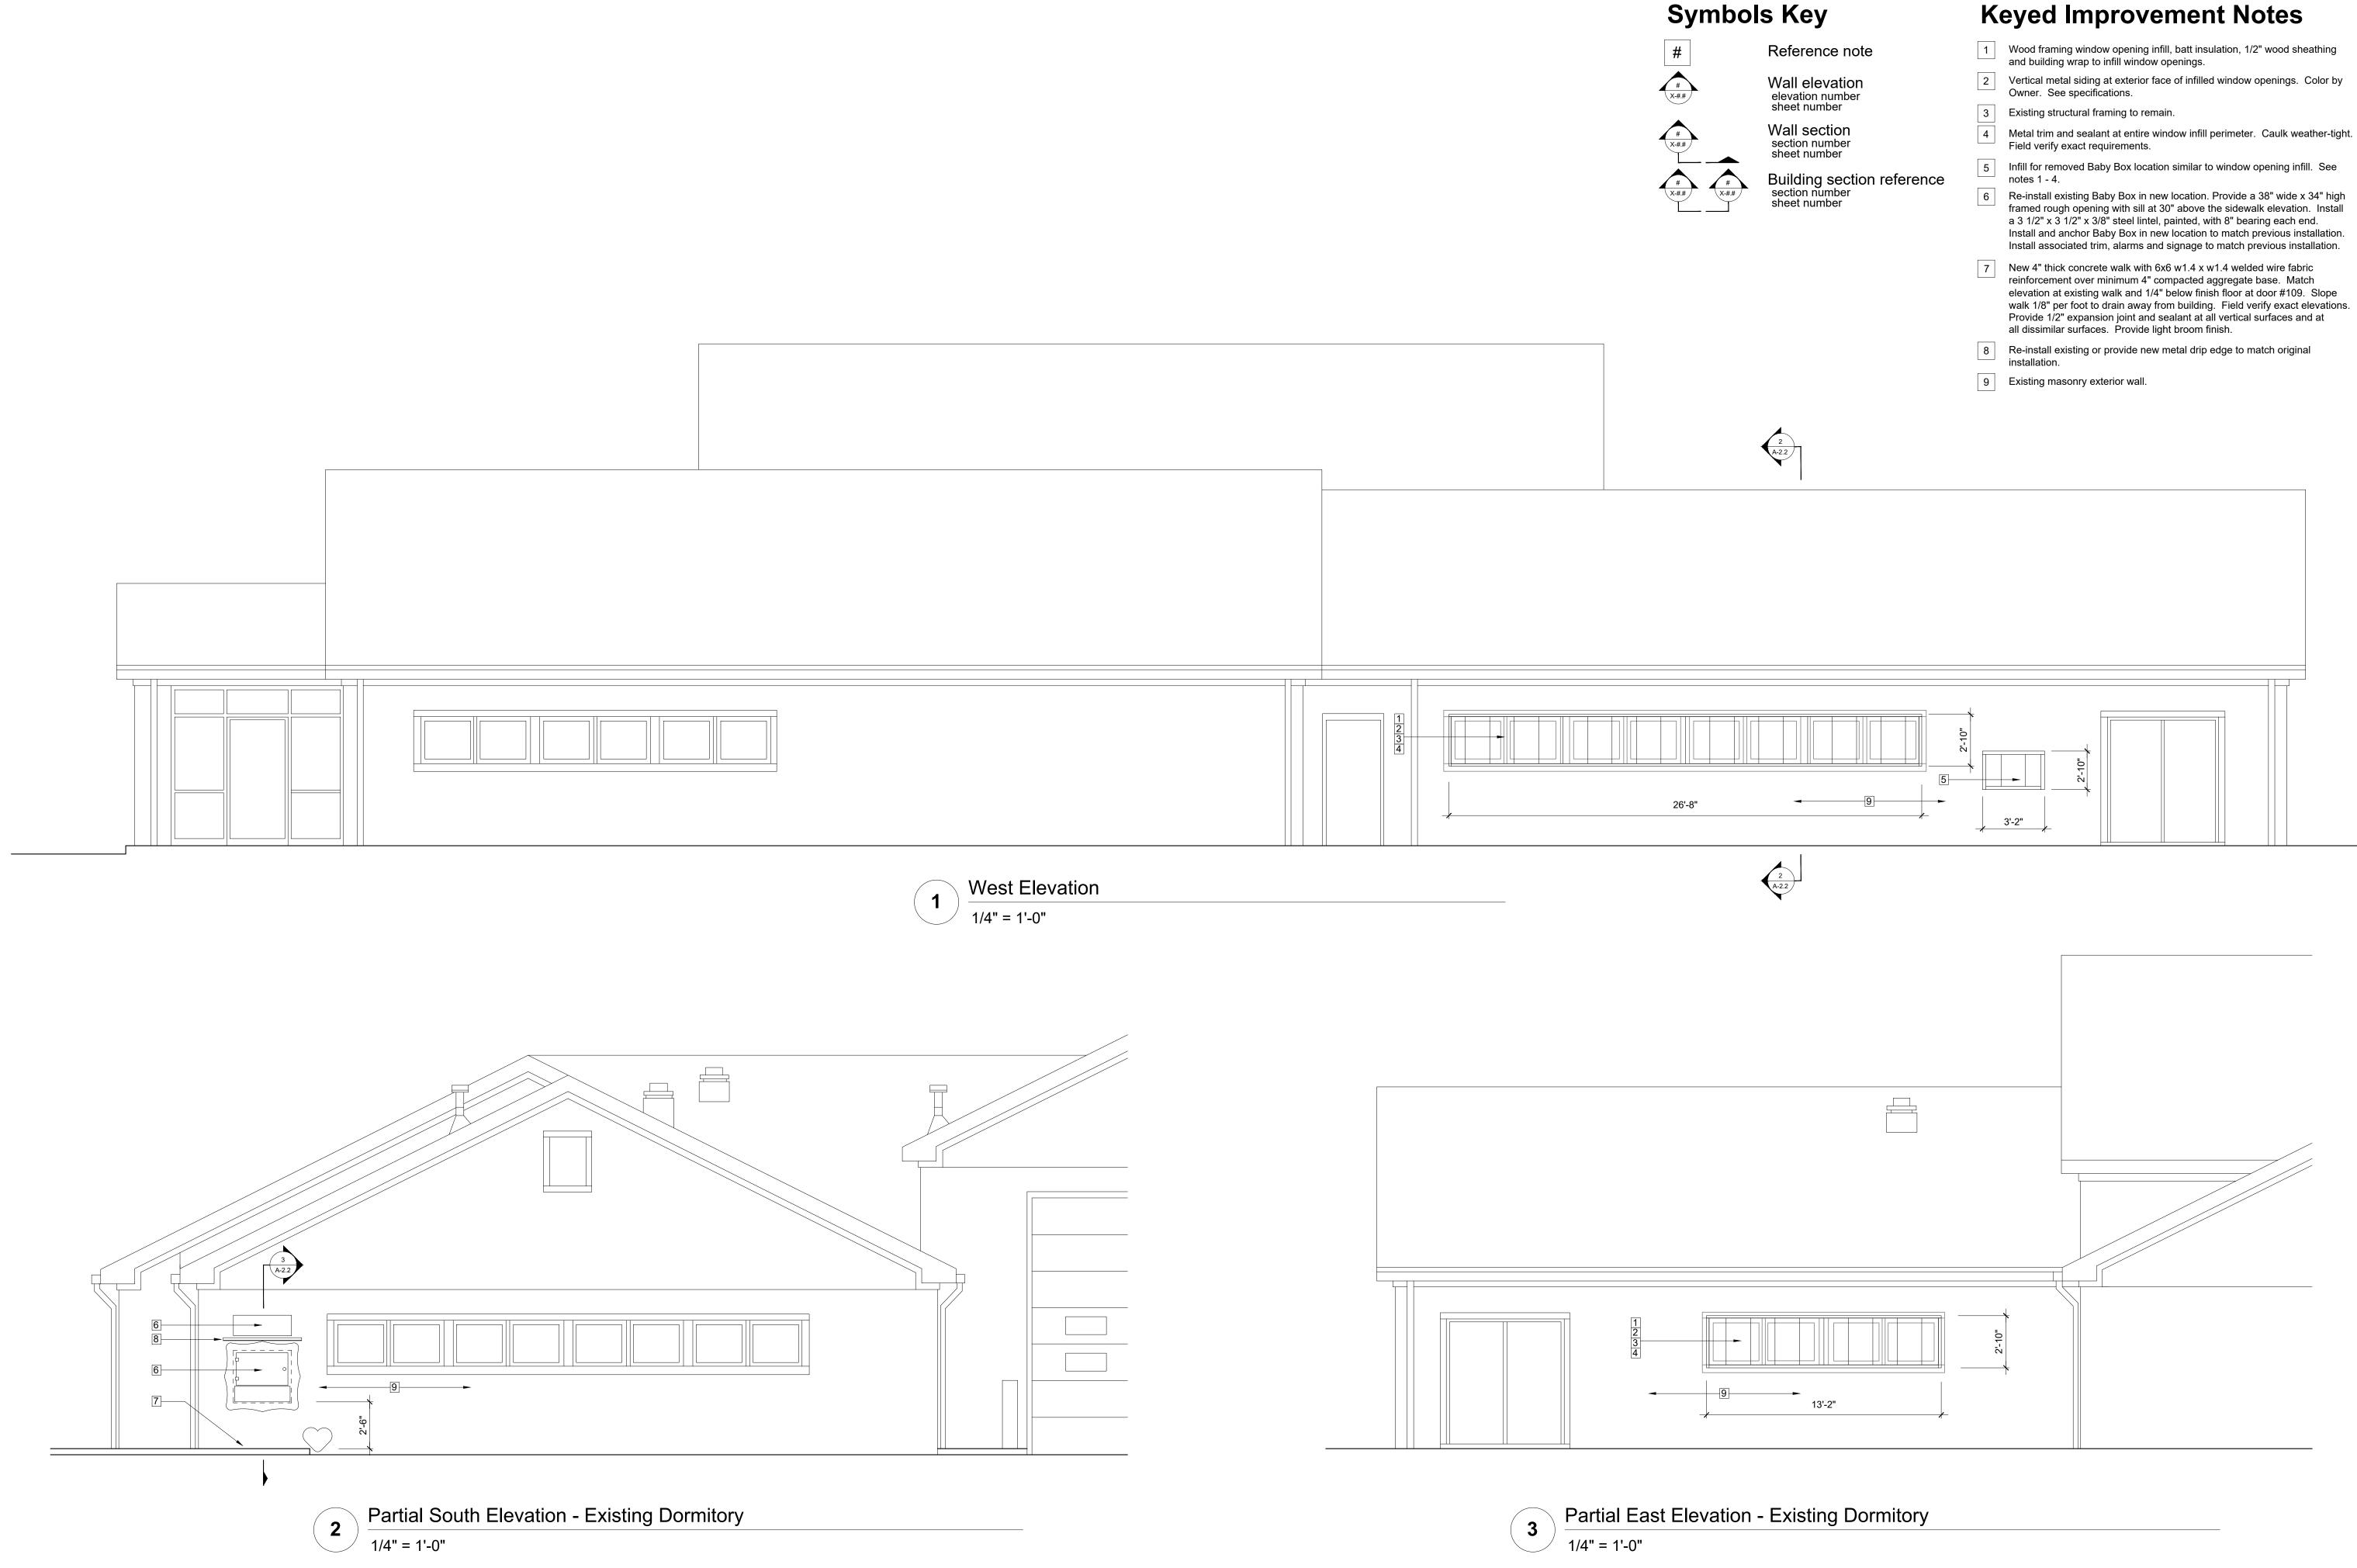
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Wall Elevations


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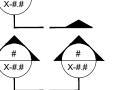
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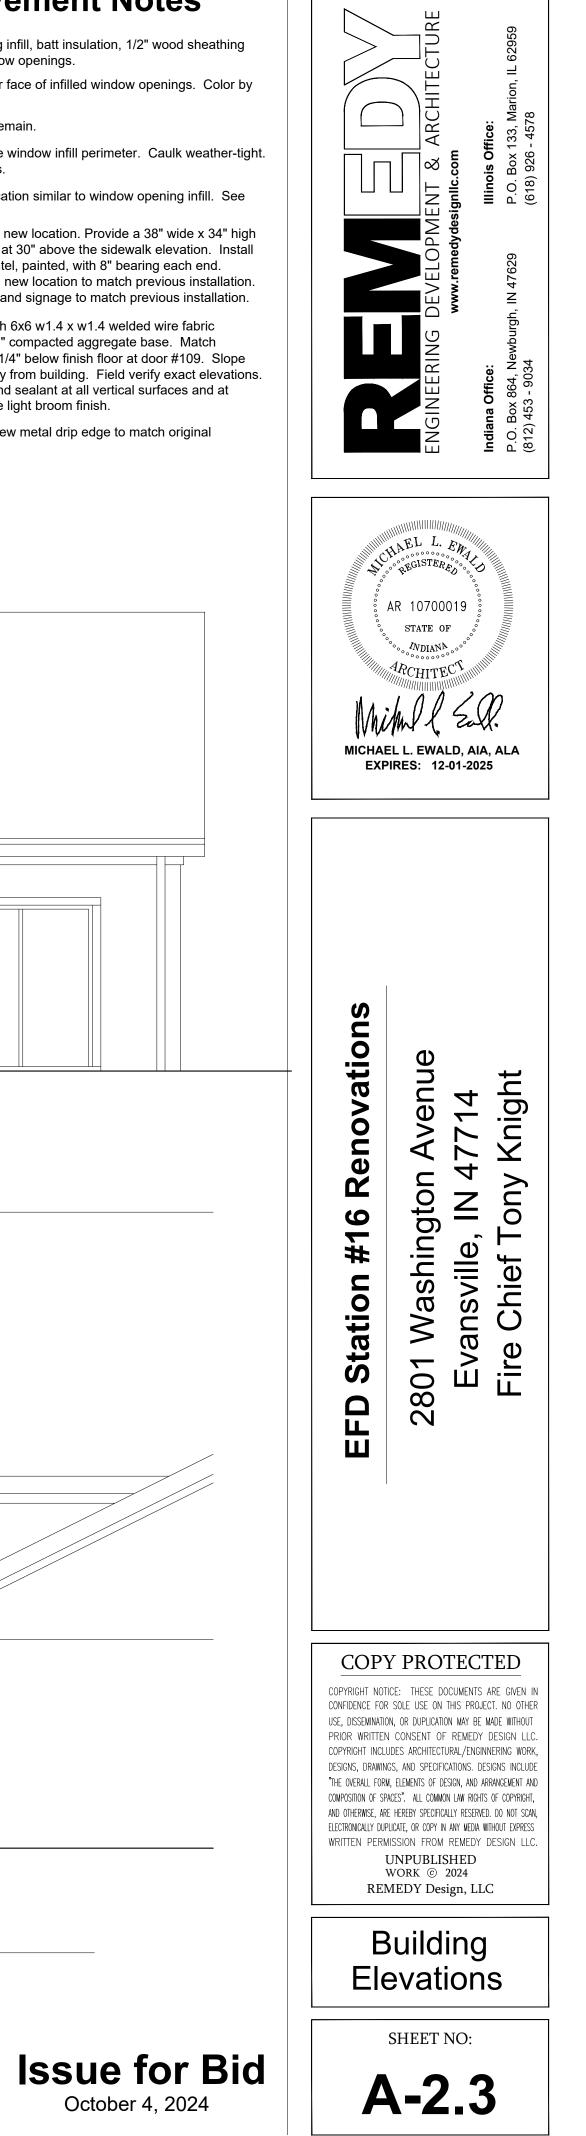


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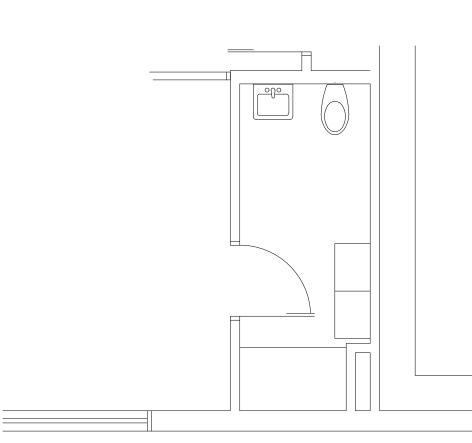







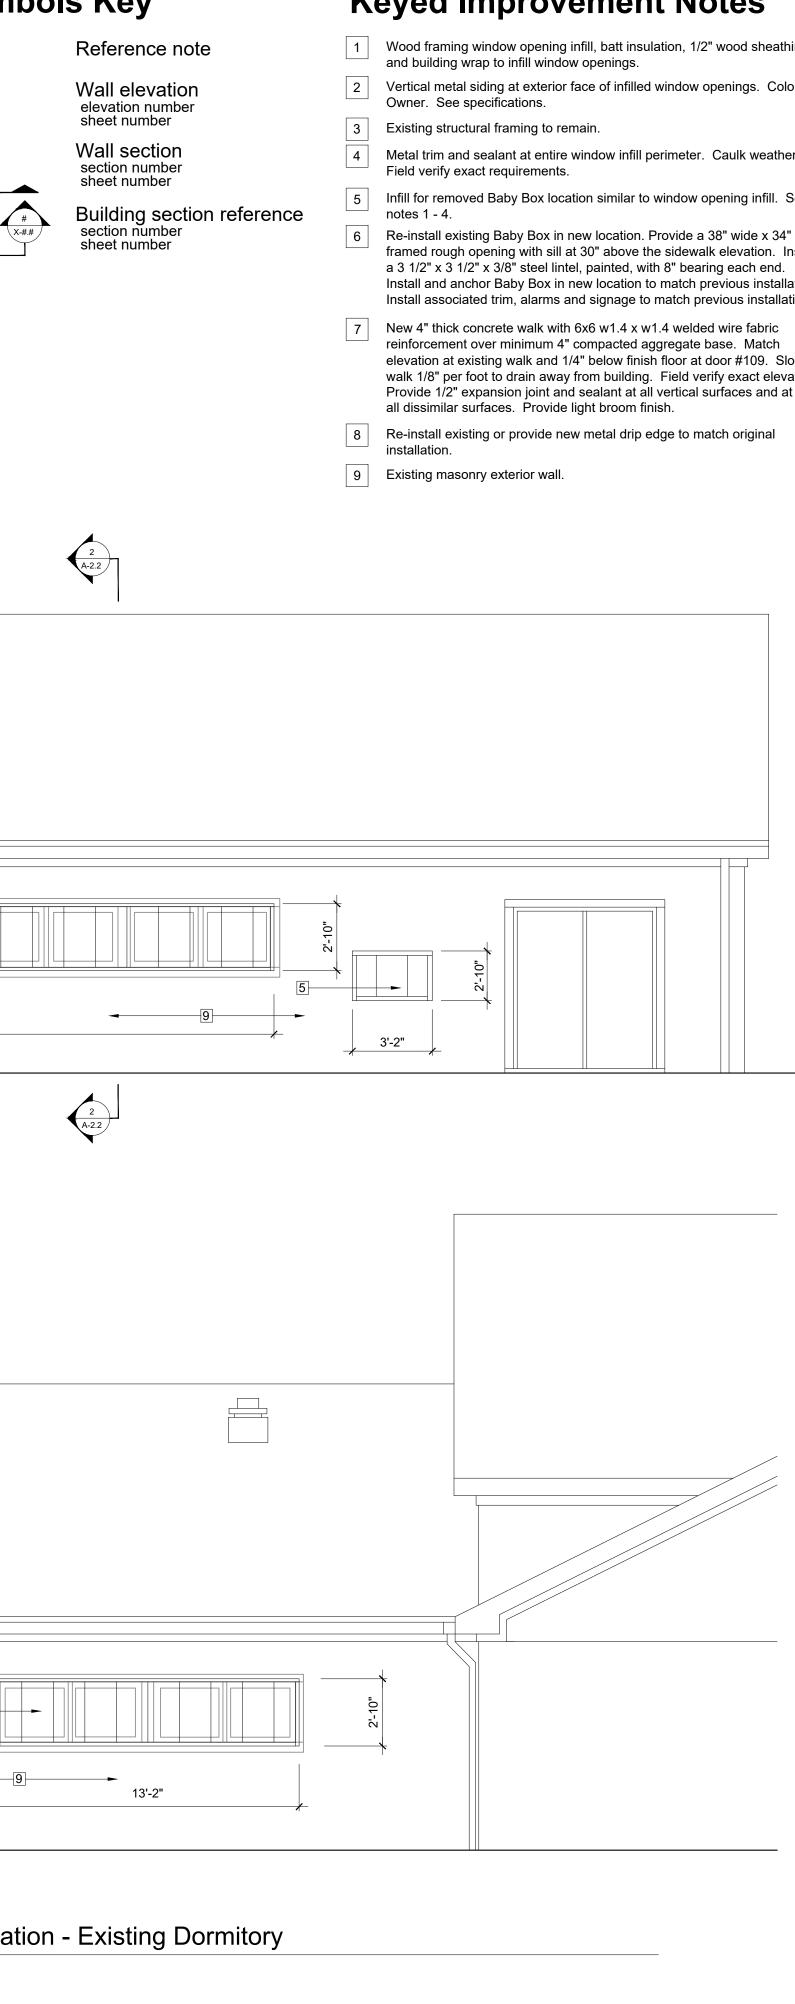


BC Bay



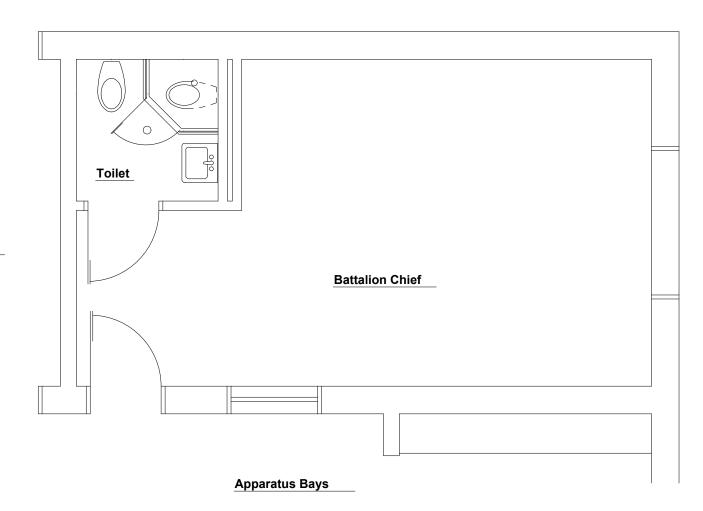




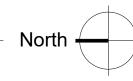

Reference Notes

1 22 1/2" x 42" attic scuttle in new gypsum board ceiling. Field verify actual location. Provide painted 5/8" plywood scuttle cover and painted nominal 1" x 2" painted wood perimeter trim.

Symbols Key

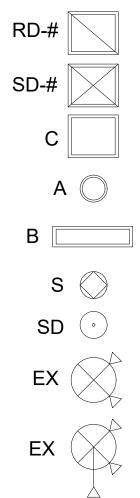

Return air grille - lay-in or ceiling surface mount

Supply air grille - lay-in mount

2' x 2' light fixture - lay-in mount

6" LED downlight fixture - acoustical tile mount

Surface mount LED ceiling light fixture

Communications speaker - acoustical tile mount Smoke detector - acoustical tile surface mount

Wall or ceiling mount exit / emergency light with battery back-up


Directional wall or ceiling mount emergency / exit light with battery back-up


Issue for Bid


October 4, 2024


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Reflected Ceiling Plan								
SHEET NO: A-2.4								



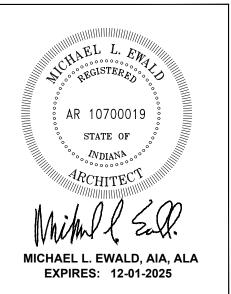

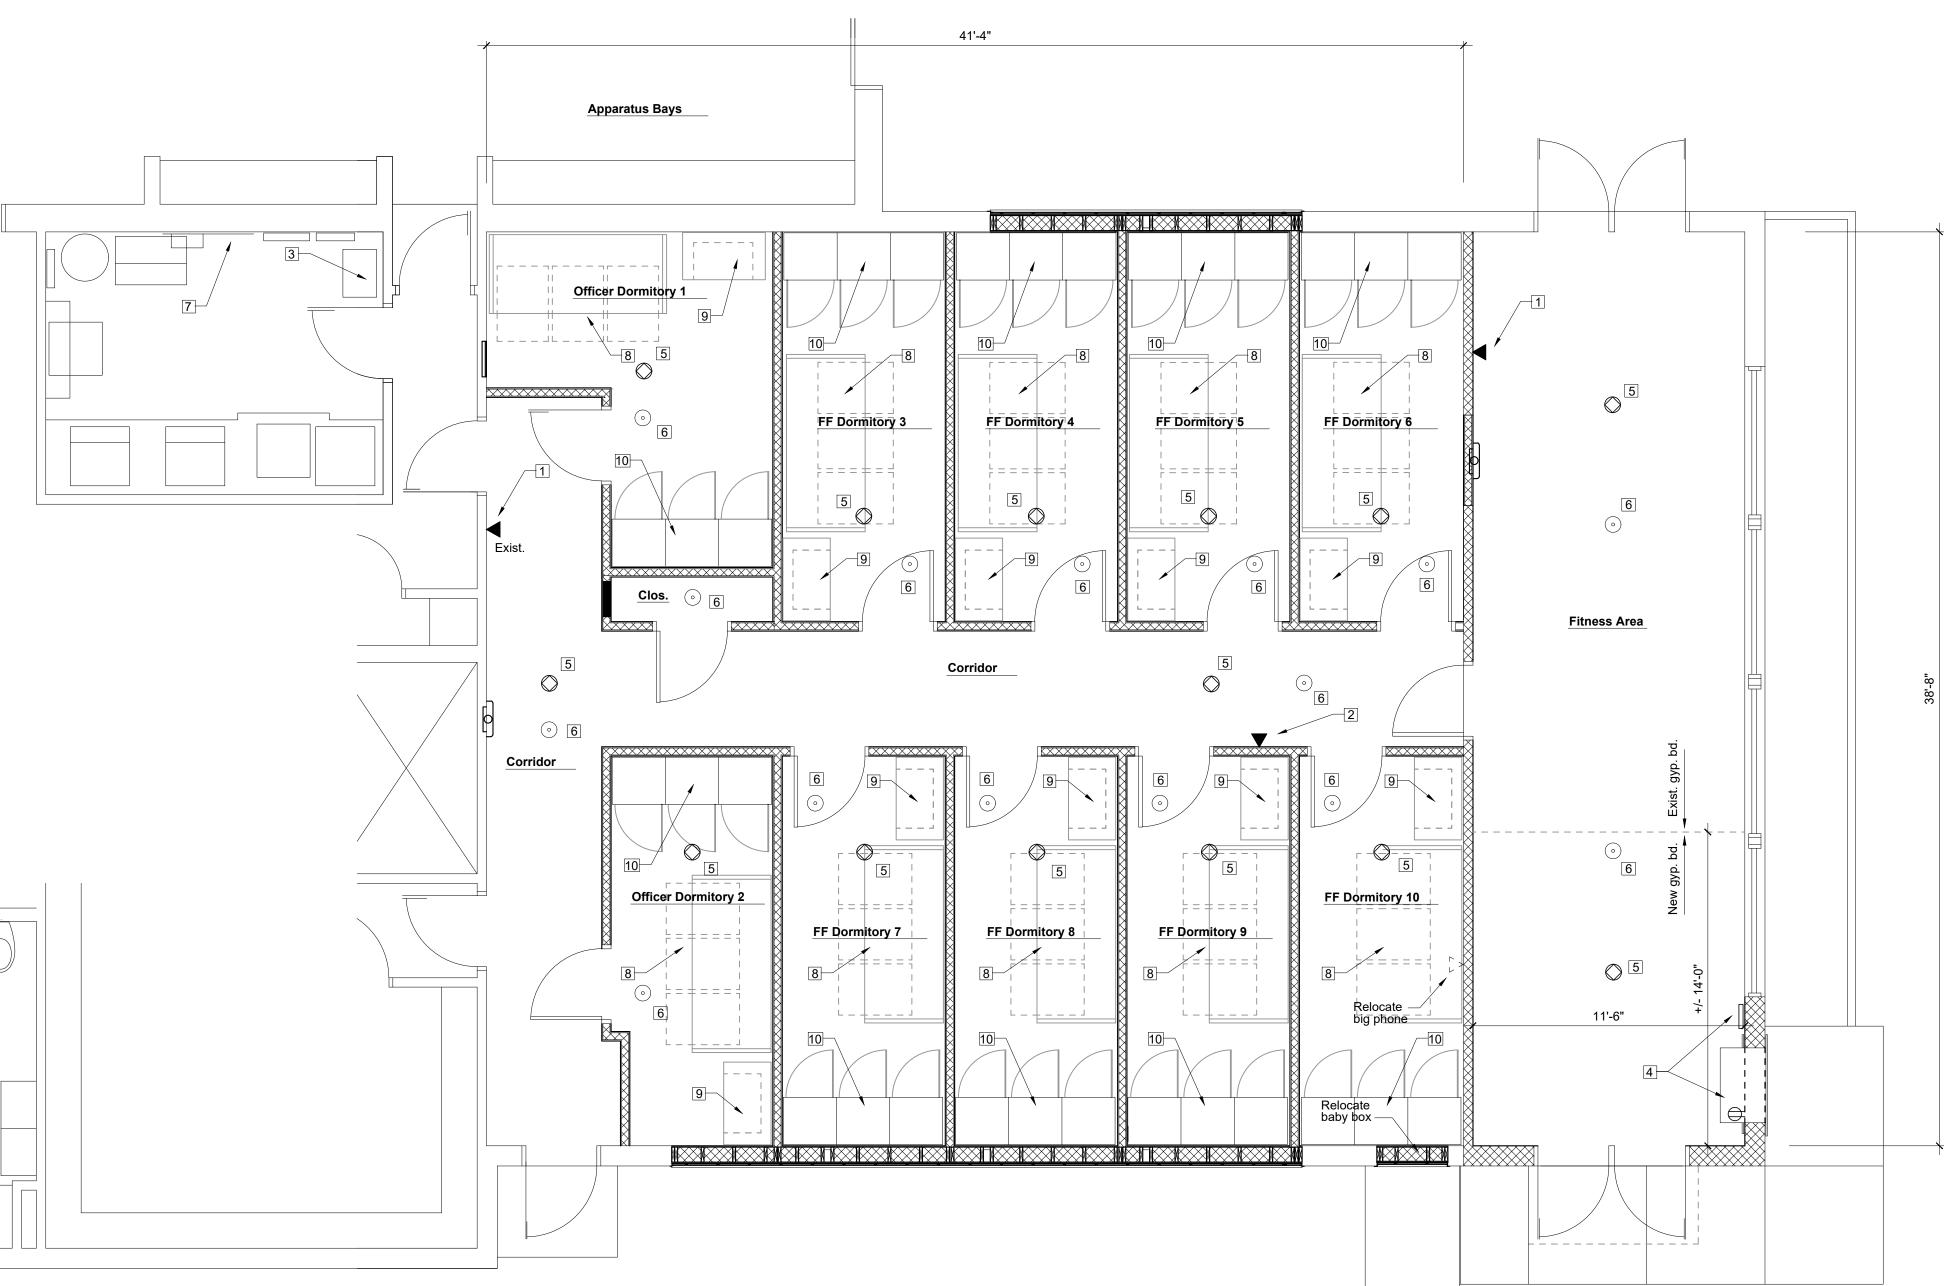

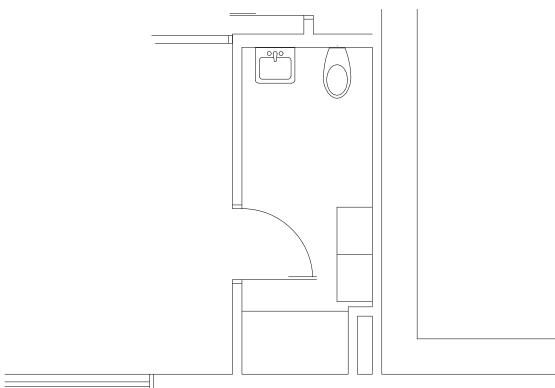

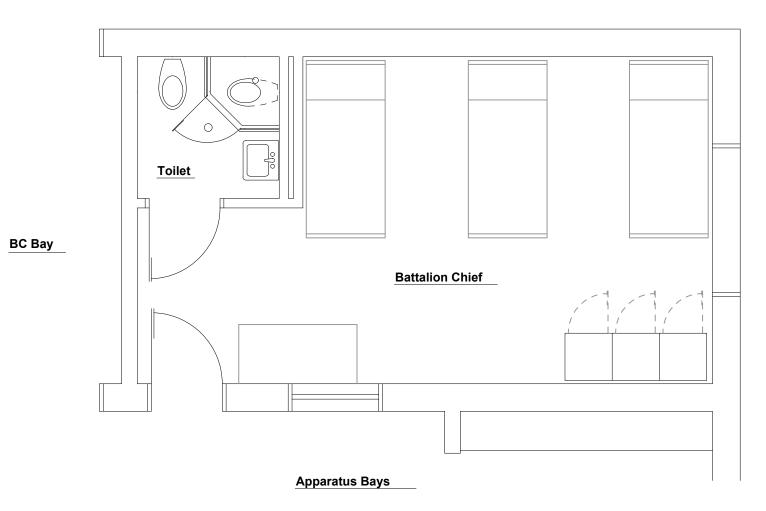

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Symbols Key

 \bigcirc New communications speaker to match, or compatible with existing system, with low voltage wiring tied into existing station speaker system (\cdot) Ceiling mount smoke detector Dedicated "big phone" wall outlet new, relocated, or additional location with low-voltage wiring connected to existing system < 1 Removed or relocated "big phone" wall outlet. \Box 120V. duplex receptacle at Baby Box.

Baby Box alarm system wall annunciator

panél with low-voltage wiring, extended to new location

Safe Haven Baby Box

Existing Station #16 Safe Haven Baby Box to be carefully removed and re-installed in new location to match existing installation and in accordance with SHBB printed installation specifications.

Coordinate all work with EFD Facilities Mgr., Safe Haven Baby Box, and Evansville Vanderburgh County Central Dispactch.

Upon installation, fully test baby box operation. Test shall be witnessed and documented by EFD personnel.

Reference Notes


- 1 Existing "big phone" and wall receptacle to remain. Protect from damage during construction. "Big phone" to remain in service unless service interruption is approved by the Owner.
- 2 Relocated "big phone" and wall receptacle. "Big phone" to remain in service unless service interruption is approved by the Owner.
- 3 Existing radio amplification equipment location. Field verify exact scope of work for new and relocated speaker unit installations.
- Relocated Safe Haven Baby Box. Extend low-voltage wiring and alarm annunciator panel to new location adjacent to baby box. Provide 120v. power for baby box door local alarm.
- Relocated existing ceiling speakers and new speakers to match existing system, installed in new locations and tied into existing system. Test entire speaker system for proper operation. Test shall be witnessed by EFD personnel and documented.
- Acoustical tile ceiling surface mounted, battery operated smoke detectors in each dormitory, in corridor and fitness area. Field verify exact locations.
- 7 Existing telephone service board in existing mechanical room.
- New firefighter bed unit with three storage drawers below. See specifications. See also Alternate Bid - 1.
- New 36" desk and office chair furnished and installed by the Owner.
- 10 New 3 unit wardrobe lockers at each dormitory. See sheet A-2.2 and specifications. See also Alternate Bid - 2.


Issue for Bid

October 4, 2024

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GENERAL REQUIREMENTS:

- A. REGULATORY REQUIREMENTS:
 - INDIANA BUILDING CODE (IBC 2014 WITH INDIANA AMENDMENTS)
 NATIONAL ELECTRIC CODE (NEC).
 - 3. NATIONAL FIRE PROTECTION ASSOCIATION (NFPA).
- 4. AMERICANS WITH DISABILITIES ACT (ADA).

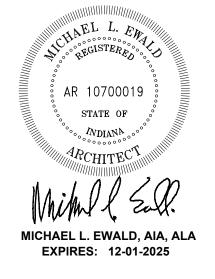B. CUTTING AND PATCHING: PERFORM ALL CUTTING AND PATCHING USING EXPERIENCED WORKERS. PROTECT ADJACENT SURFACES AND SYSTEMS DURING CUTTING AND PATCHING OPERATIONS. PATCH SURFACES USING SIMILAR MATERIALS. BLEND ALL PATCHING TO NEAREST CORNER OR LOGICAL TERMINATION TO PROVIDE AN AESTHETICALLY PLEASING FINISH APPEARANCE.

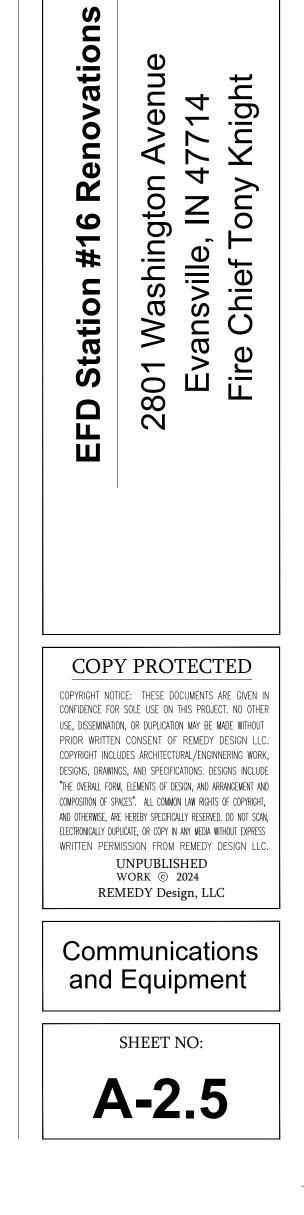ALL SURFACES AFFECTED BY CUTTING AND PATCHING SHALL BE FINISHED TO PROVIDE A COMPLETE, FINISHED SYSTEM OR ASSEMBLY, OR NEAREST CORNER.

C. PERMITS AND FEES:

CONTRACTOR SHALL SECURE AND PAY FOR ALL PERMITS AND INSPECTIONS REQUIRED BY LOCAL LAWS AND ORDINANCES.

D. CONTRACTOR SHALL FILED VERIFY ALL NEW AND EXISTING DIMENSIONS AND ELEVATIONS. REPORT ANY DISCREPANCIES TO THE ARCHITECT IN WRITING BEFORE COMMENCING WORK.

VISIT TO THE SITE: THE CONTRACTOR MUST VISIT THE SITE BEFORE SUBMITTING HIS BID AND THOROUGHLY INSPECT SAME TO FAMILIARIZE HIMSELF WITH ALL CONDITIONS WHICH MAY AFFECT NEW INSTALLATION OF WORK UNDER THE CONTRACT. CLAIM FOR EXTRA COMPENSATION DUE TO THE EXISTING CONDITIONS WILL NOT BE CONSIDERED.

E. SUBSTITUTION PROCEDURES: BIDDERS MAY SUBMIT PRODUCTS FOR APPROVAL PRIOR BIDDING. PRODUCTS SUBMITTED AFTER BIDS ARE OPENED WILL BE CONSIDERED IF THEY ARE EQUAL TO, OR EXCEED, THE PRODUCT SPECIFIED AS BASIS OF DESIGN. SUBSTITUTIONS ARE THE CONTRACTOR'S RESPONSIBILITY. PRODUCTS DETERMINED NOT EQUAL TO THE SPECIFIED OR BASIS OF DESIGN PRODUCT WILL BE REJECTED, AND THE CONTRACTOR SHALL FURNISH THE ACCEPTABLE PRODUCT.

F. CONTRACTOR SHALL DELIVER TO THE ARCHITECT AND OWNER, SUBMITTALS FOR ALL FINISHES, EQUIPMENT AND FURNISHINGS. SUBMITTALS SHALL BE COMPLETE TO SHOW QUALITY OF MATERIALS, CONSTRUCTION AND INSTALLATION. SUBMITTALS SHALL PROVIDE COLOR CHARTS OR MATERIAL SAMPLES SUFFICIENT TO ALLOW FOR COLOR SELECTIONS TO BE MADE.

G. USE OF EXISTING WATER AND POWER ON SITE WILL BE PERMITTED AS LONG AS IT DOES NOT INTERFERE WITH FIRE STATION OPERATIONS. IF ADDITIONAL SERVICES ARE REQUIRED IN ADDITION TO THOSE IDENTIFIED FOR USE, THE CONTRACTOR SHALL SUPPLY SAID SERVICES AND INCLUDE ALL COSTS FOR SAME IN HIS BID. THE CONTRACTOR SHALL PROVIDE AND MAINTAIN PORTABLE TOILETS ON THE SITE FOR USE BY TEH CONSTRUCTION PERSONNEL. SERVICE TOILETS REGULARLY.

H. MATERIALS DELIVERED AND STORED ON THE SITE SHALL BE DONE IN A MANNTER AS TO NOT INTERFERE WITH THE FIRE STATION OPERATIONS. COORDINATE WITH TEH OWNER'S FACILITY MANAGER FOR THE PLACEMENT AND OPERATION OF JOB TRAILERS, EQUIPMENT STORAGE AND CONSTRUCTION PERSONNEL DAILY PARKING AT THE SITE.

I. PRIOR TO FINAL CLOSEOUT, SUBMIT TO THE ARCHITECT AND OWNER A COMPLETE OPERATIONS AND MAINTENANCE REPORT LISTING PRODUCTS, WARRANTY INFORMATION, AND CONTRACT INFORMATION. PROVIDE A SIGNED AND DATED ONE-YEAR MATERIALS AND WORKMANSHIP WARRANTY DOCUMENT. DELIVER ALL KEYS TO THE OWNER AND COORDINATE WITH THE OWNER'S FACILITY MANAGER FOR THE ACCEPTANCE OF EXTRA STOCK FOR ITEMS SUCH AS PAINT, FLOOR TILE, ATHLETIC FLOORING, CEILING TILES, CARPET TILES, RESILIENT BASE AND PAINT.

TECHNICAL SPECIFICATIONS - ARCHITECTURAL WORK:

CONTRACTOR SHALL FILED VERIFY ALL NEW AND EXISTING DIMENSIONS AND ELEVATIONS. REPORT ANY DISCREPANCIES TO THE ARCHITECT IN WRITING BEFORE COMMENCING WORK.

VISIT TO THE SITE: THE CONTRACTOR MUST VISIT THE SITE BEFORE SUBMITTING HIS BID AND THOROUGHLY INSPECT SAME TO FAMILIARIZE HIMSELF WITH ALL CONDITIONS WHICH MAY AFFECT NEW INSTALLATION OF WORK UNDER THE CONTRACT. CLAIM FOR EXTRA COMPENSATION DUE TO THE EXISTING CONDITIONS WILL NOT BE CONSIDERED.

DIVISION 7 - THERMAL AND MOISTURE PROTECTION:

PATCH OR REPLACE EXISTING FIBERGLASS INSULATION DAMAGED DURING RENOVATION OR FOUND OUT OF PLACE DURING THE WORK. NEW INTERIOR WALLS SHALL RECEIVE SOUND ATTENUATION BATTS, FULL HEIGHT. R-38 MINIMUM AT CEILINGS, R-19 MINIMUM AT EXTERIOR WALLS AND R-13 MINIMUM AT INTERIOR WALLS.

SOUND ATTENUATION BATT INSULATION BASIS OF DESIGN, ROCKWOOL SAFE-N-SOUND, OR EQUIVALENT, R-38 MINIMUM AT CEILINGS AND R-19 MINIMUM AT EXTERIOR WALLS AND R-13 MINIMUM AT INTERIOR WALLS.

NEW METAL SIDING BASIS OF DESIGN: MBCI, OR EQUIVALENT, FW-120 VERTICAL ARCHITECTURAL METAL PANEL SIDING, CONCEALED FASTENER, FLAT PROFILE, SMOOTH FINISH, 12" PANEL WIDTH, 24 GAUGE, WITH SIGNATURE 300 COATING, COLOR BY OWNER.

DIVISION 8 - DOORS, FRAMES AND HARDWARE:

WOOD DOORS BASIS OF DESIGN: MARSHFIELD, OR EQUIVALENT, 1 3/4" THICKNESS, SOLID CORE, PLAIN SLICED WHITE MAPLE, PRE-MACHINED, PRE-FINISHED, 48-97 "NUTMEG" STAIN COLOR, OR AS SELECTED BY THE OWNER TO MATCH EXISTING DOORS IN THE FACILITY. PROVIDE GLASS LIGHT KITS TO MATCH EXISTING DOORS WHERE SHOWN. DOORS SHALL BE FIRE RATED WHERE INDICATED.

METAL FRAMES BASIS OF DESIGN: STTELCRAFT, F SERIES, 16 GAUGE STEEL, WELDED CONSTRUCTION, 5 3/4" JAMB THROAT WIDTH, WITH Q146 SILENCERS. PRIMED AND PAINTED. COLOR AS SELECTED BY OWNER. DOOR FRAMES SHALL BE FIRE RATED WHERE INDICATED.

DOOR HARDWARE BASIS OF DESIGN: HAGER, OR EQUIVALENT, HEAVY-DUTY, US26D FINISH, UNLESS NOTED OTHERWISE:

LOCKSETS: HAGER, 3500 SERIES, GRADE 2, AUGUST LEVER PRIVACY - 3540

PASSAGE - 3510

HINGES: HAGER, BALL BEARING HINGES, ECBB 1100, 4 1/2" CLOSERS: HAGER 5200 SERIES WITH 5203 PARALLEL ARM, ALM FINISH STOPS: HAGER, 236 W

DIVISION 9 - FINISHES: PAINT SHALL BE SHERWIN WILLIAMS, OR EQUIVALENT, BEST QUALITY PRODUCT LINE. NEW AND EXISTING SURFACES TO BE PAINTED: PREPARE SURFACES AND APPLY PRIMER WITH TWO (2) COATS FINISH.

CARPET TILE: BASIS OF DESIGN IS MOHAWK BASICS, COMMERCIAL TEXTURED LOOP, PATTERNED TILE SQUARES, 24" X 24" SQUARES, .086 PILE HEIGHT. COLOR AND PATTERN BY THE OWNER. 10 YEAR LIMITED WARRANTY.

RUBBER BASE SHALL BE JOHNSONITE, OR EQUIVALENT, 4" TALL RUBBER BASE. COLORS SHALL BE AS SELECTED BY THE OWNER.

RUBBER ATHLETIC FLOORING: BASIS OF DESIGN IS FITFLOORS, INC., SPECIALIZED RUBBER FLOORING, 1/4" THICKNESS, BLACK COLOR, 48" WIDE X 15' LONG ROLLS, ADHERED WITH MANUFACTURER'S RECOMMENDED URETHANE ADHESIVE.

QUARRY TILE TO MATCH BATTALION CHIEF TOILET ROOM FLOORING: BASIS OF DESIGN, SUMMITVILLE QUARRY TILE, 6" X 6" X 1/2" UNGLAZED QUARRY TILE, COLOR AND GROUT TO MATCH EXISTING TILE TO REMAIN AS CLOSELY AS POSSIBLE.

ACOUSTICAL TILE CEILINGS: BASIS OF DESIGN IS ARMSTRONG FIREGUARD #896, FISSUED, SQUARE EDGE, 24" X 24" X 5/8", 0.55 NRC. WHITE COLOR.

LAY-IN GRID BASIS OF DESIGN: ARMSTRONG PRELUDE 15/16" TEE. WHITE COLOR.

DIVISION 12 - FURNISHINGS:

FIREFIGHTER BEDS: BASIS OF DESIGN IS FIRE STATION FURNITURE, OR EQUIVALENT, TWIN XL STORAGE LOCKER BED, SOLID WOOD CONSTRUCTION, WITH 3 LOCKABLE STORAGE UNITS BENEATH FRAME, 85" LONG X 42" WIDE X 38" HIGH, STORAGE UNITS 25" WIDE X 31" LONG X 19" HIGH, WITH WOOD SLATS AND MATTRESS. WOOD STAIN COLOR BY OWNER. EACH OFFICER OR FIREFIGHTER DORMITORY TO RECEIVE 1 STORAGE BED UNIT.

WARDROBE LOCKERS: BASIS OF DESIGN IS CASE SYSTEMS ATHLETIC LOCKER TL 411 / TL 412. 26" WIDE X 24" DEEP X 87" HIGH WITH DRAWER BASE STORAGE COMPARTMENT WITH VENTILATION GRILL, PERSONAL STORAGE CUBBY, GARMENT HOOKS, NUMBER PLATE, LOCKS AND KEYS, MANUFACTURER'S STANDARD HARDWARE, HIGH PRESSURE LAMINATE - COLOR BY OWNER. WITH FILLER PANELS AS REQUIRED FOR A COMPLETE INSTALLATION. EACH OFFICER OR FIREFIGHTER DORMITORY TO RECEIVE 3 LOCKER UNITS. SEE ALTERNATE BID 2.


ANCHOR LOCKERS TO WALL PER MANUFACTURER'S INSTRUCTIONS FOR SEISMIC ANCHORAGE AND TIP RESISTANCE.

"

TECHNICAL SPECIFICATIONS - MEP WORK:

A. SEE REPSECTIVE PLUMBING, MECHANICAL AND ELECTRICAL SHEETS.


	ENGINEERING DEVELOPMENT & ARCHITECTURE www.remedydesignilc.com	Indiana Office: Illinois Office: P.O. Box 864, Newburgh, IN 47629 P.O. Box 133, Marion, IL 62959 (812) 453 - 9034 (618) 926 - 4578
	STATE OF	AIA, ALA
EFD Station #16 Renovations		Fire Chief Tony Knight
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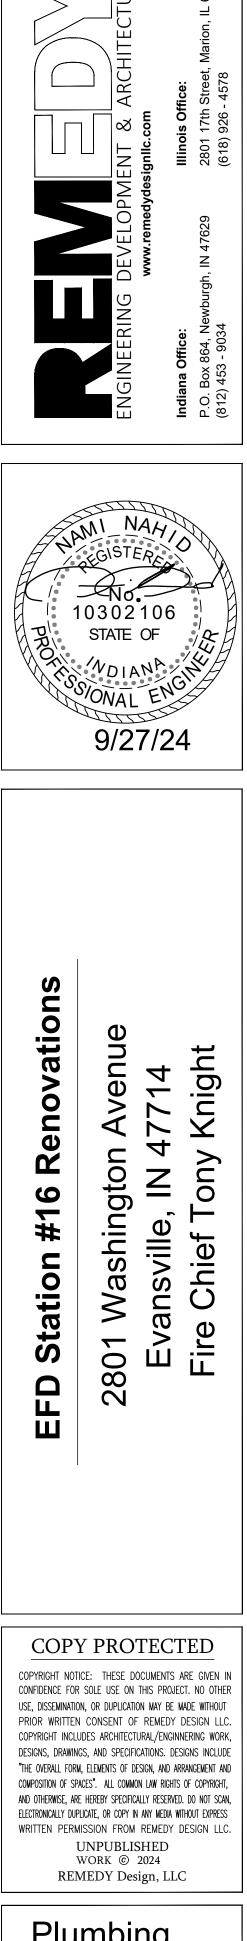
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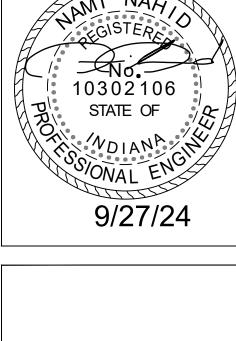


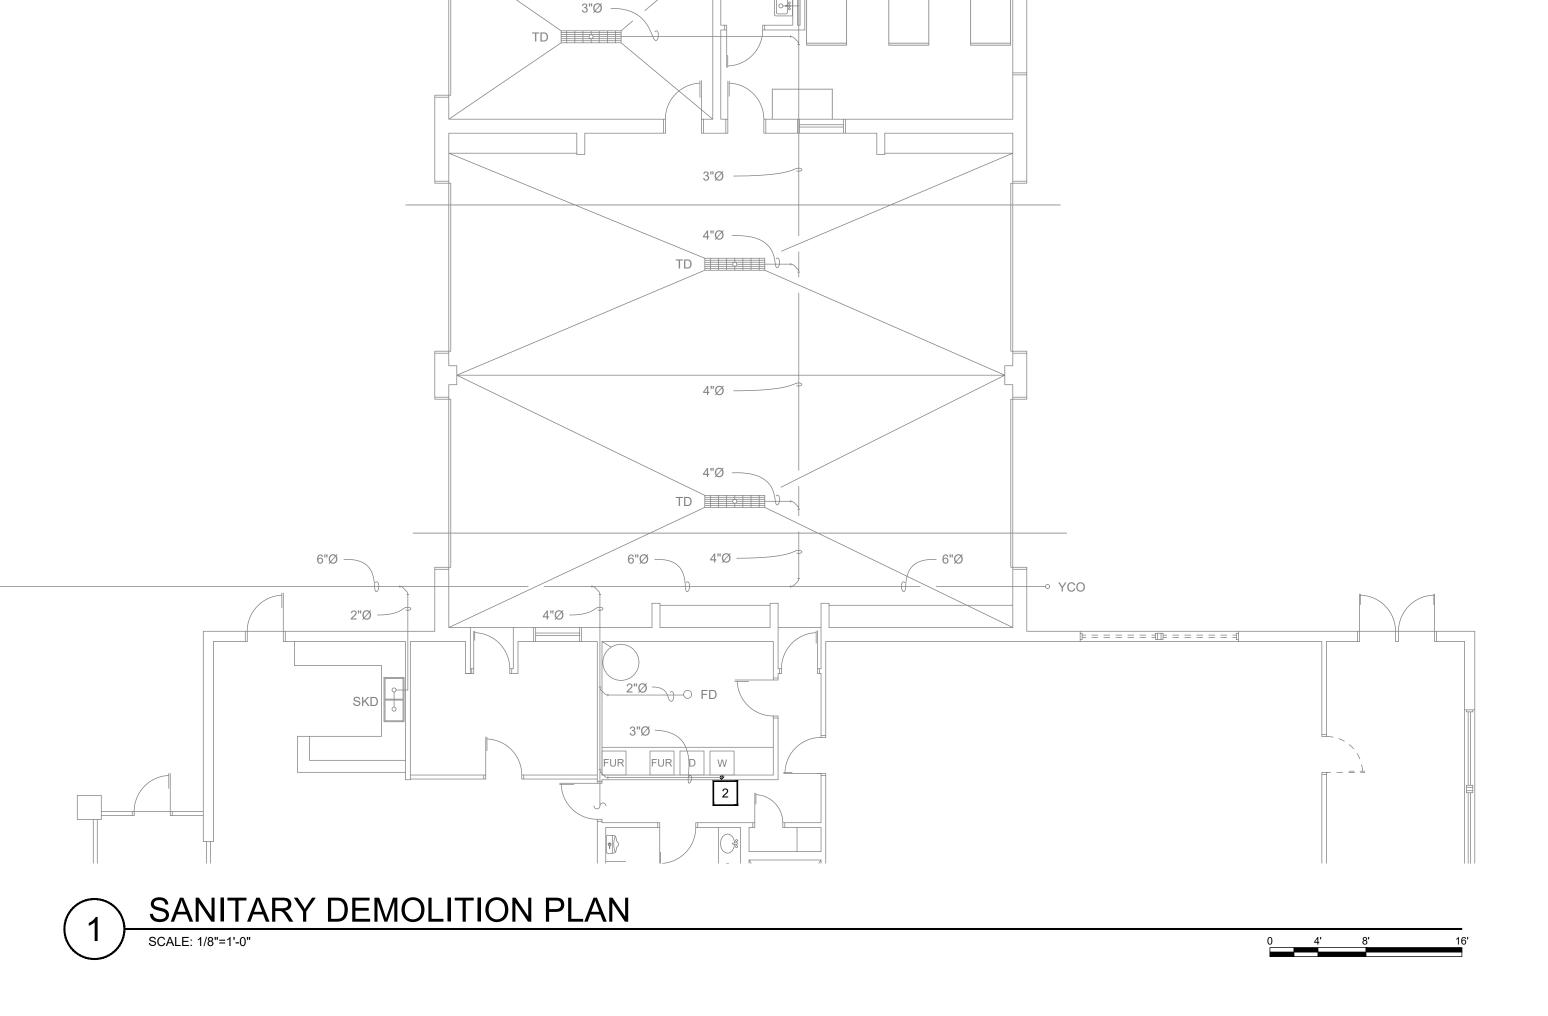DEMOLITION NOTES # 1. DEMO COMPLETE SANITARY SEWER LINE FROM WATER CLOSET TO SEWER MAIN. REMOVE SECTION OF EXISTING WASHER AND DRYER 3" SANITARY LINE TO DRAIN NEW STACKABLE WASHER/DRYER.

CONSTRUCTION NOTES

- 1. CONNECT NEW WATER CLOSET/SHOWER SANITARY LINE TO EXISTING MAIN. TIE IN NEW WATER CLOSET VENT TO EXISTING 3" VENT MAIN.
- 2. CONNECT NEW STACKABLE WASHER/DRYER TO EXISTING SANITARY LINE. CONNECT NEW VENT TO EXISTING 2" VENT. SEE RISER FOR DETAILS.




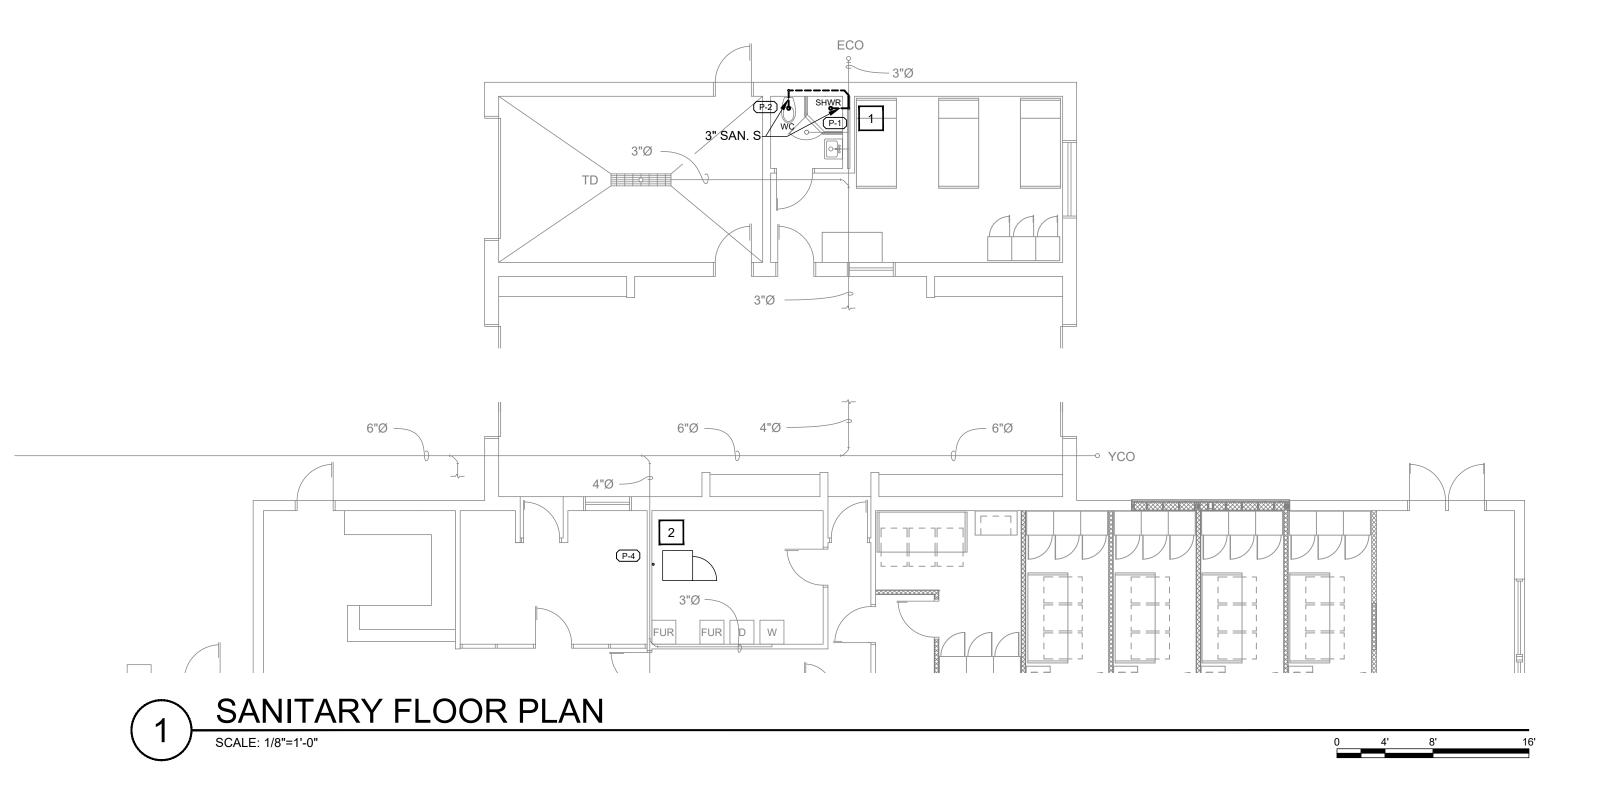




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ENGINEERING MECHANICAL • ELECTRICAL • PLUMBING 1830 DESTINY LANE, SUITE 113 BOWLING GREEN, KY (270) 599-0182 ACT JUSTLY, LOVE MERCY, WALK HUMBLY



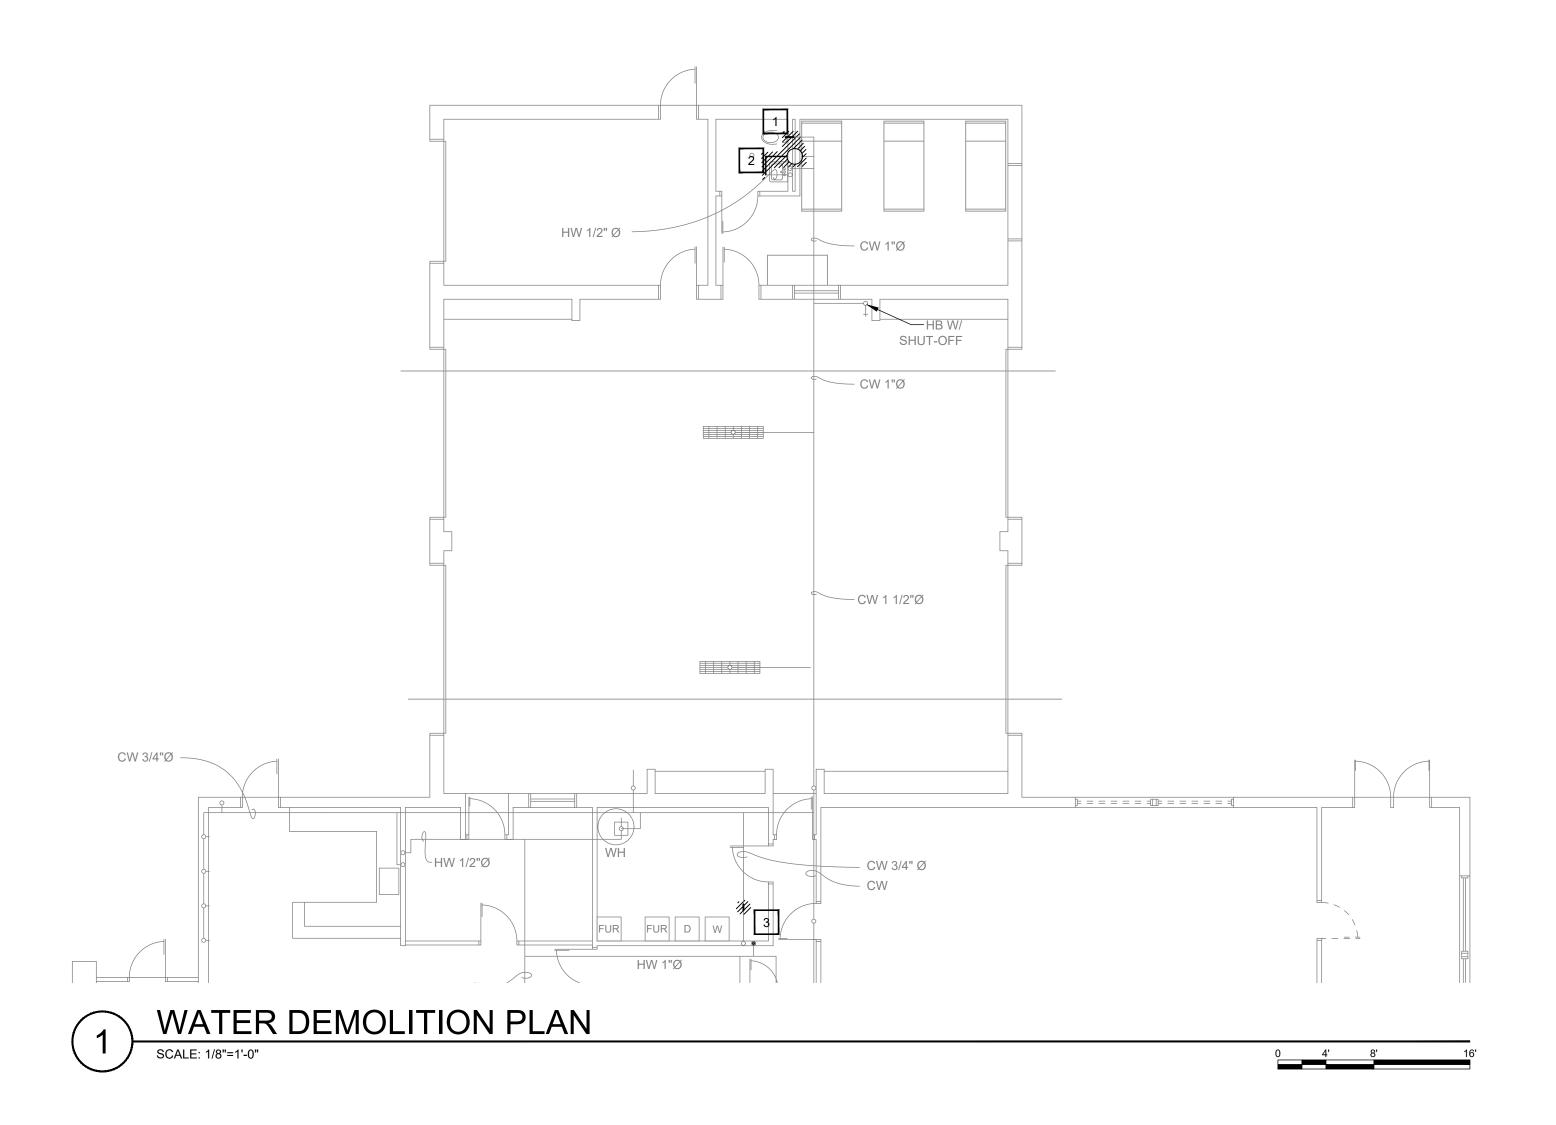


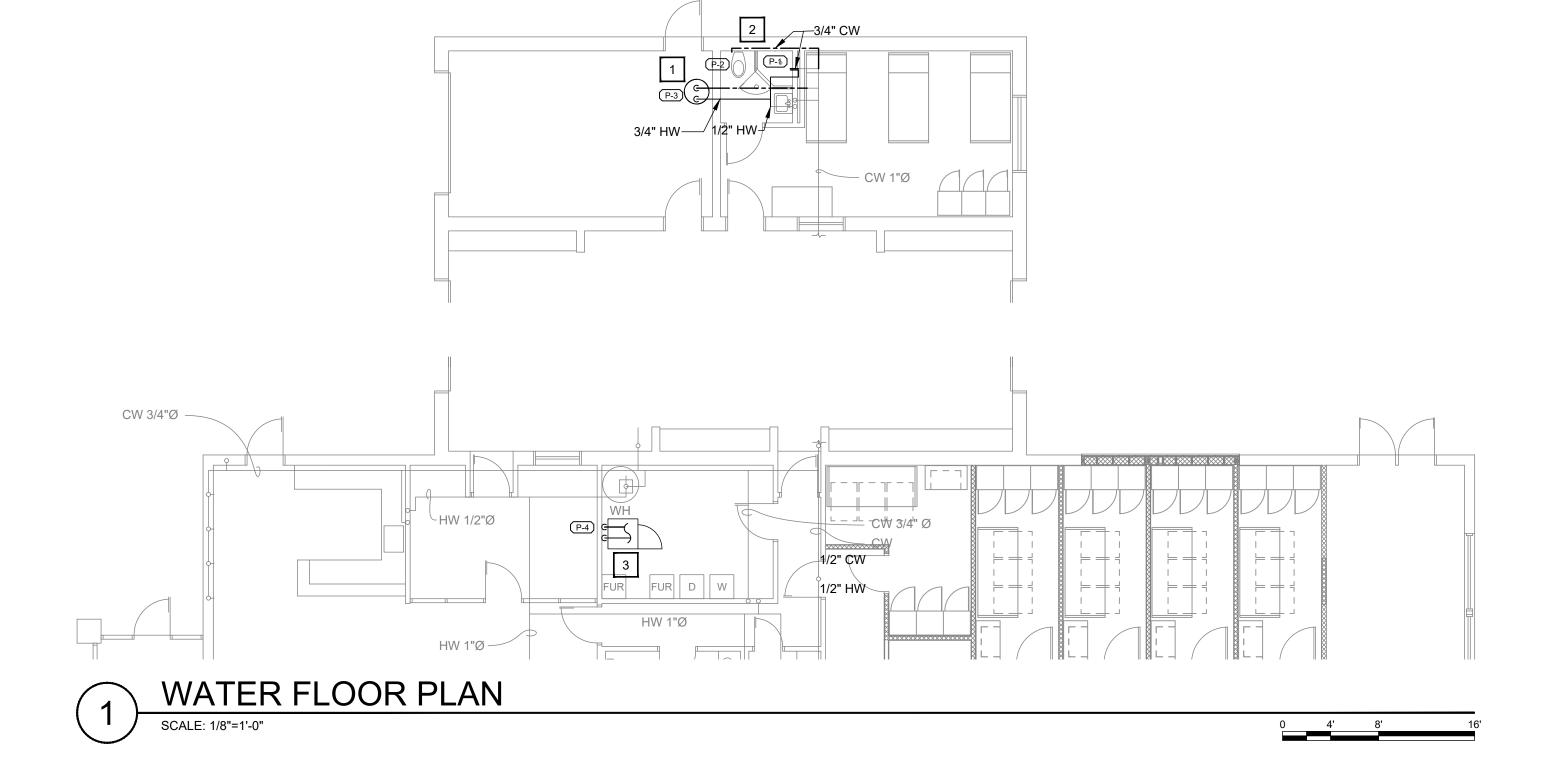DEMOLITION NOTES

- 1. DEMO COLD WATER LINE FROM TOILET FOR NEW SHOWER.
- 2. DEMO EXISTING HOT WATER HEATER ABOVE CEILING AND HW LINE.
- REMOVE SECTION OF EXISTING CW/HW TO FEED NEW STACKABLE WASHER/DRYER. MAINTAIN EXISTING LINES CW/HW LINE TO EXISTING INDUSTRIAL WASHER AND DRYER. FIELD VERIFY HOW EXISTING CW/HW LINES ARE RAN.

CONSTRUCTION NOTES

- PROVIDE & INSTALL NEW HW HEATER. MOUNT ON SHELF 7' A.F.F. RECONNECT HW TO SINK. PROVIDE NEW HW LINE TO SHOWER.
- 2. INSTALL NEW CW TO WATER CLOSET AND SHOWER.
- CONNECT NEW 1/2" CW AND HW LINES TO OUTLET BOX FOR WASHER AND DRYER. CONNECT TO MAIN IN MECH ROOM

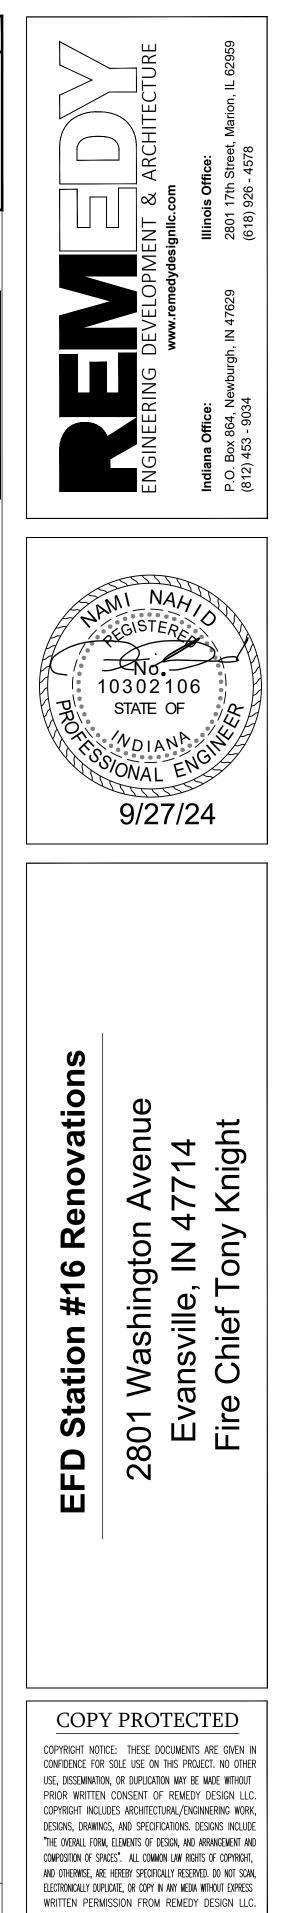

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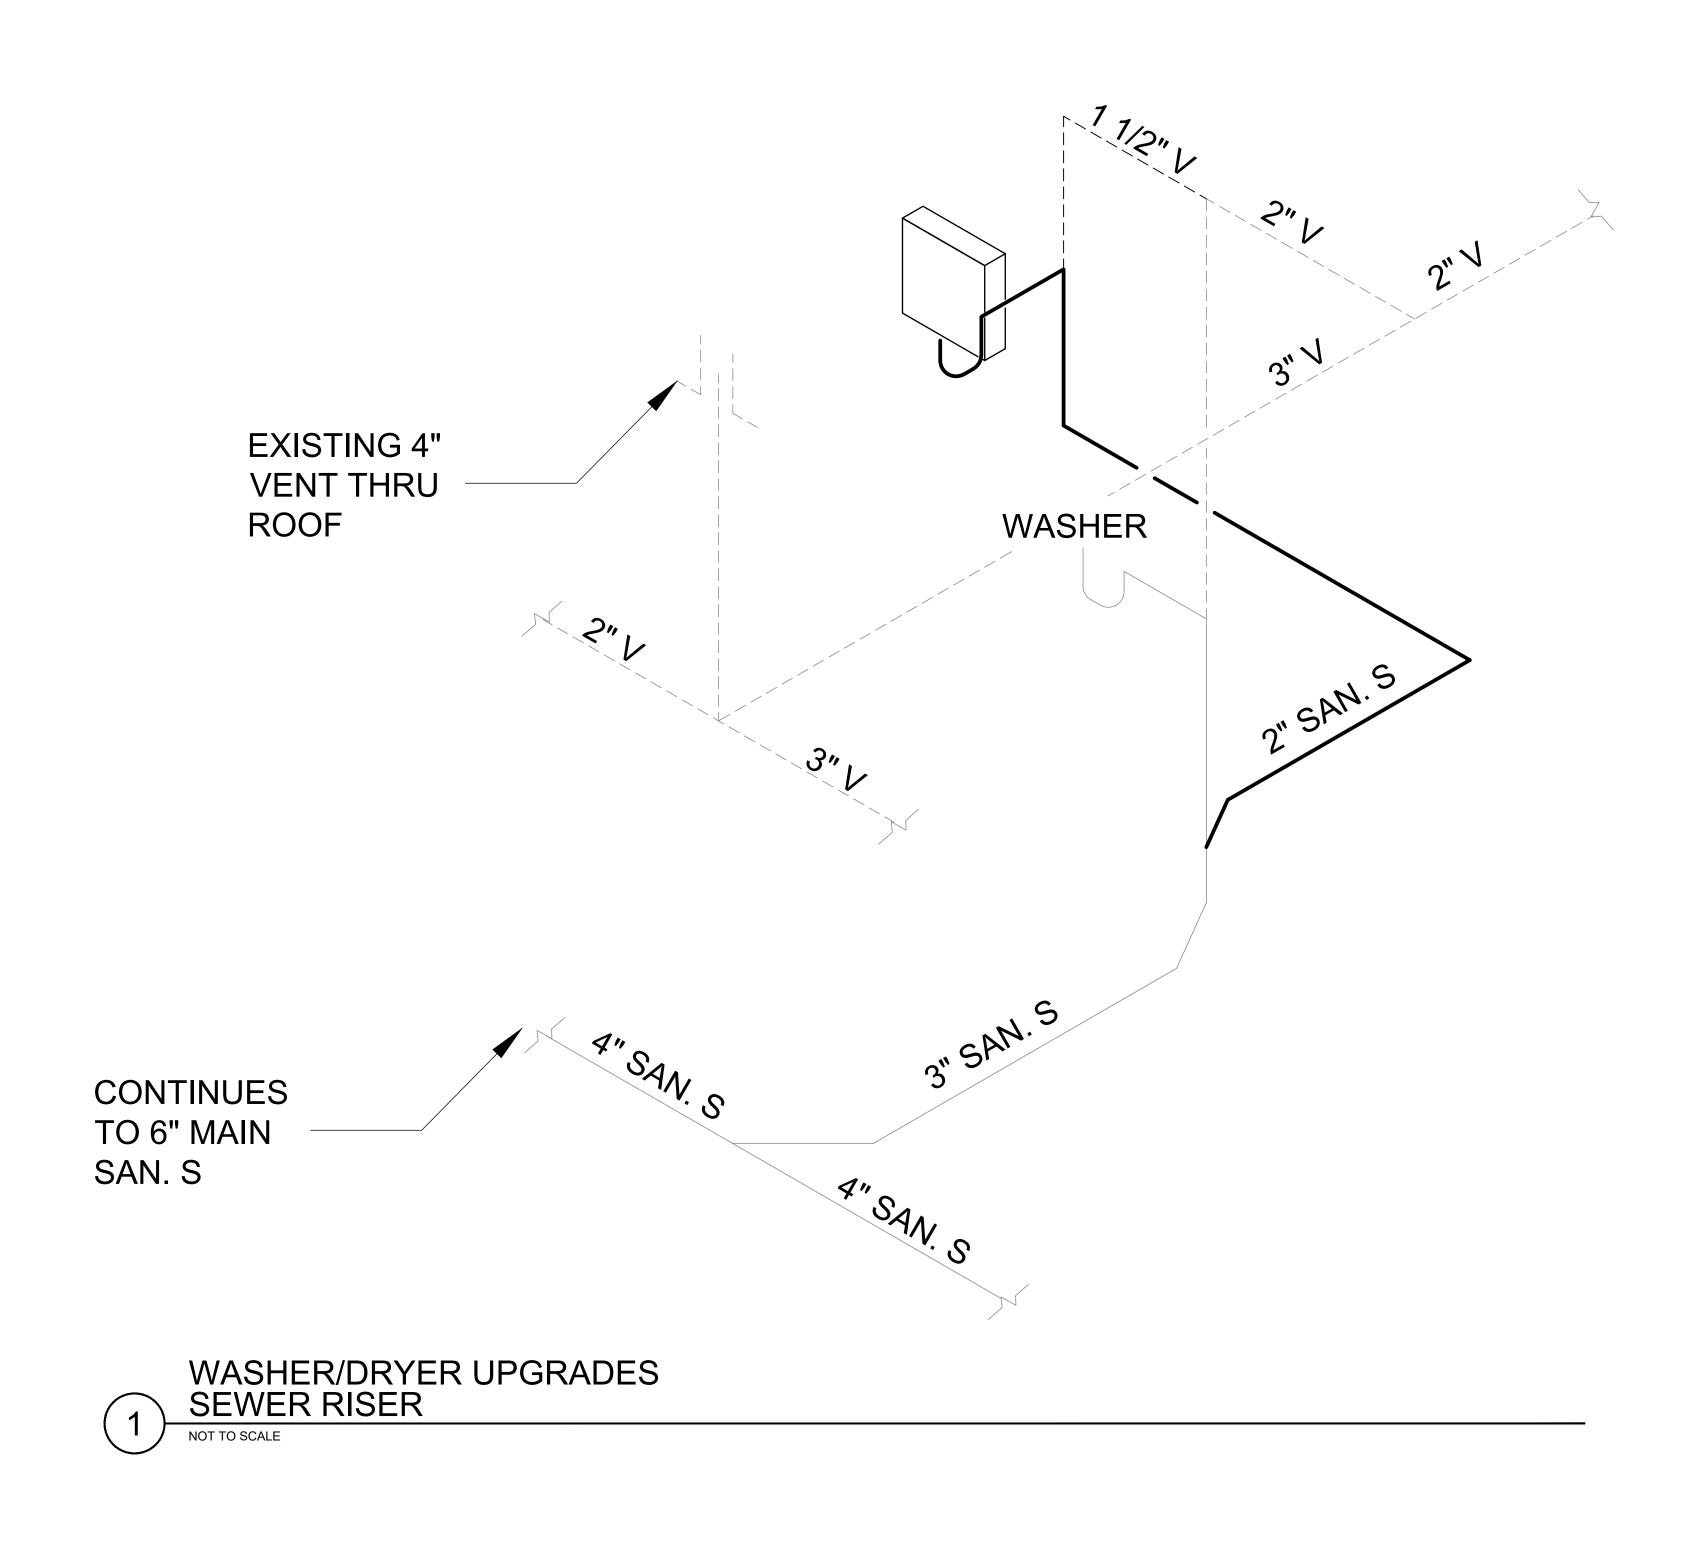
Plumbing Water Plan


SHEET NO:

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ACT JUSTLY, LOVE MERCY, WALK HUMBLY





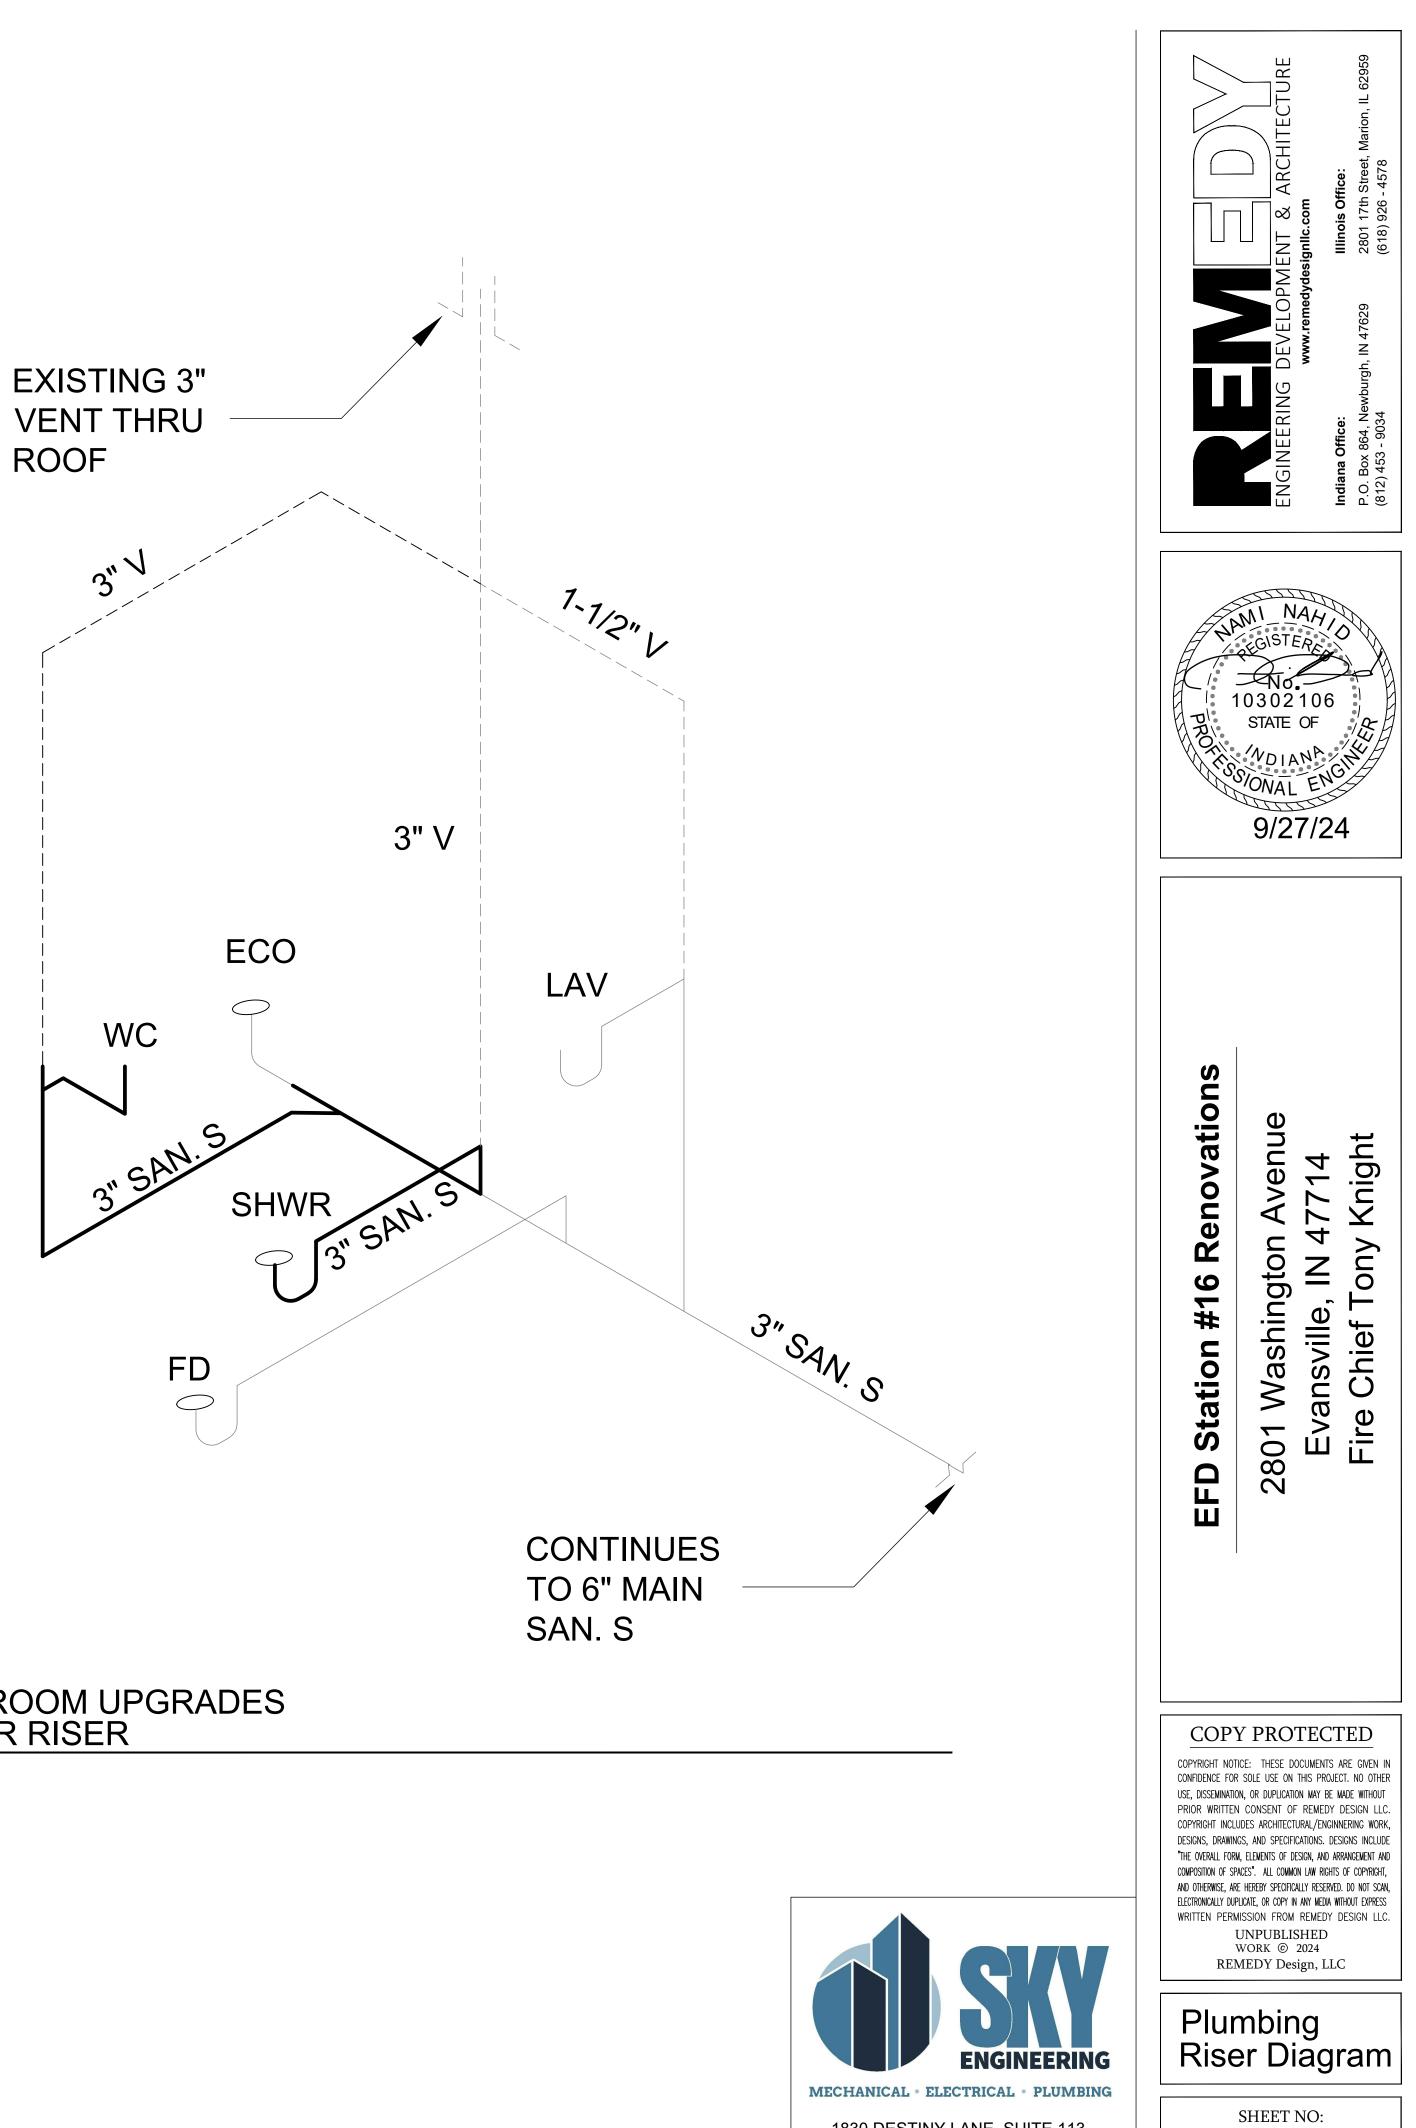


1830 DESTINY LANE, SUITE 113 BOWLING GREEN, KY (270) 599-0182 ACT JUSTLY, LOVE MERCY, WALK HUMBLY

P-1.2

GENERAL PLUMBING NOTES

- 1. ALL CONSTRUCTION DEBRIS SHALL BE DISPOSED OF BY THE CONTRACTOR, UNLESS NOTED OTHERWISE.
- 2. THERE SHALL BE NOTHING ABANDONED IN PLACE, UNLESS SPECIFICALLY IDENTIFIED AS SUCH.
- 3. THESE PLANS ARE DIAGRAMMATIC IN NATURE, CONTRACTORS SHALL INCLUDE APPROPRIATE ALLOWANCES FOR OFFSETS AS REQUIRED TO ACCOMMODATE VERTICAL AND HORIZONTAL VARIATIONS IN THE LOCATIONS AND ELEVATIONS OF DUCTWORK, PIPING AND EXISTING CONDITIONS.
- 4. EACH TRADE SHALL COORDINATE THE ROUTING AND INSTALLATION OF HIS WORK WITH THAT OF 19. VENT PIPING MAINS WITHIN PLUMBING WALL TO BE ABOVE 55" AFF TO ALLOW MOUNTING OF GFI OUTLETS NEXT TO SINKS. ROUTE VENT PIPING TO AVOID VANITY LIGHT MOUNTING LOCATION. ALL OTHER TRADES THROUGH THE GENERAL CONTRACTOR. IN ANY INSTANCES OF CONFLICT, SYSTEMS REQUIRING "GRADE" OR "SLOPE" FOR DRAINAGE (SANITARY SEWER, SANITARY VENT, COORDINATE WITH ELECTRICAL. EQUIPMENT DRAINS, ETC ...) SHALL HAVE PRIORITY.
- 5. PENETRATIONS OF WALLS OR FLOORS FOR THE PASSAGE OF PIPING, OR OTHER EQUIPMENT SHALL BE PROPERLY SEALED AFTER INSTALLATION OF EQUIPMENT. FIELD VERIFY EXISTING WALL PENETRATIONS AND PROPERLY SEAL AS REQUIRED TO MAINTAIN WALL OR FLOOR RATING.
- ALL UNDERGROUND PIPE TO BE MINIMUM OF 2" CHARLOTTE PVC UNLESS OTHERWISE NOTED. PIPING SHALL NOT RUN THRU FOUNDATION OR FOOTERS WITH A LENGTH GREATER THAN 2 FEET. WITHIN THE FOOTER CONTRACTOR SHALL PROVIDE A PIPE SLEEVE THE LENGTH OF THE PENETRATION, 2 INCHES LARGER THAN THE PENETRATING PIPE, LASTLY, THE PIPE MUST BE ARMAFLEX INSULATED AND APPROVED BY LOCAL AHJ.
- 7. PROVIDE ALL EQUIPMENT, MATERIAL, LABOR, SUPERVISION, COSTS AND SERVICES REQUIRED TO 24. BACK TO BACK FLUSH VALVE WATER CLOSETS TO BE INSTALLED USING A DOUBLE "Y" CONNECTION. SEE RISER INSTALL COMPLETE AND WORKING SYSTEMS, INCLUDING ALL ITEMS AND APPURTENANCES NECESSARY, REASONABLE, INCIDENTAL OR CUSTOMARILY INCLUDED, EVEN THOUGH EACH AND EVERY ITEM IS NOT SPECIFIED OR SHOWN. 25. PIPING MUST CONFORM TO LOCAL AND STATE SEISMIC CODES.
- 8. ALL WORK SHALL COMPLY WITH THE REQUIREMENTS OF THE CONTRACT DOCUMENTS, INCLUDING 26. SMOKE TIGHT FOR PIPING PENETRATION THRU SMOKE TIGHT WALL. ADDENDA, AND APPLICABLE CODES AND STANDARDS.
- 9. PROVIDE ACCESS TO ALL CONCEALED EQUIPMENT AND VALVES. COORDINATE LOCATION OF ACCESS PANELS WITH ARCHITECT. PROVIDE ACCESS PANELS FOR CONCEALED VALVES AND OPEN SITE DRAINS.
- 10. ALL FLOOR DRAINS, FLOOR SINKS, HUB DRAINS, OR INDIRECT CONNECTIONS SHALL BE PROVIDED 29. EXPOSED PIPING IN FINISHED SPACES SHALL BE PAINTED. WITH TRAP PRIMER VALVE(S) EXTENDING TO NEAREST COLD WATER SUPPLY UNLESS SHOWN
- 11. VENT STACK SHALL BE LOCATED A MINIMUM OF 10'-0" AWAY FROM ANY HVAC UNIT.
- 12. EXTEND SANITARY SEWER, DOMESTIC WATER, STORM, AND FIRE MAIN PIPING AS REQUIRED IN ORDER TO CONNECT TO STUB-OUT PROVIDED BY CIVIL.
- 13. INSTALL STOPS IN SUPPLIES TO ALL FIXTURES.

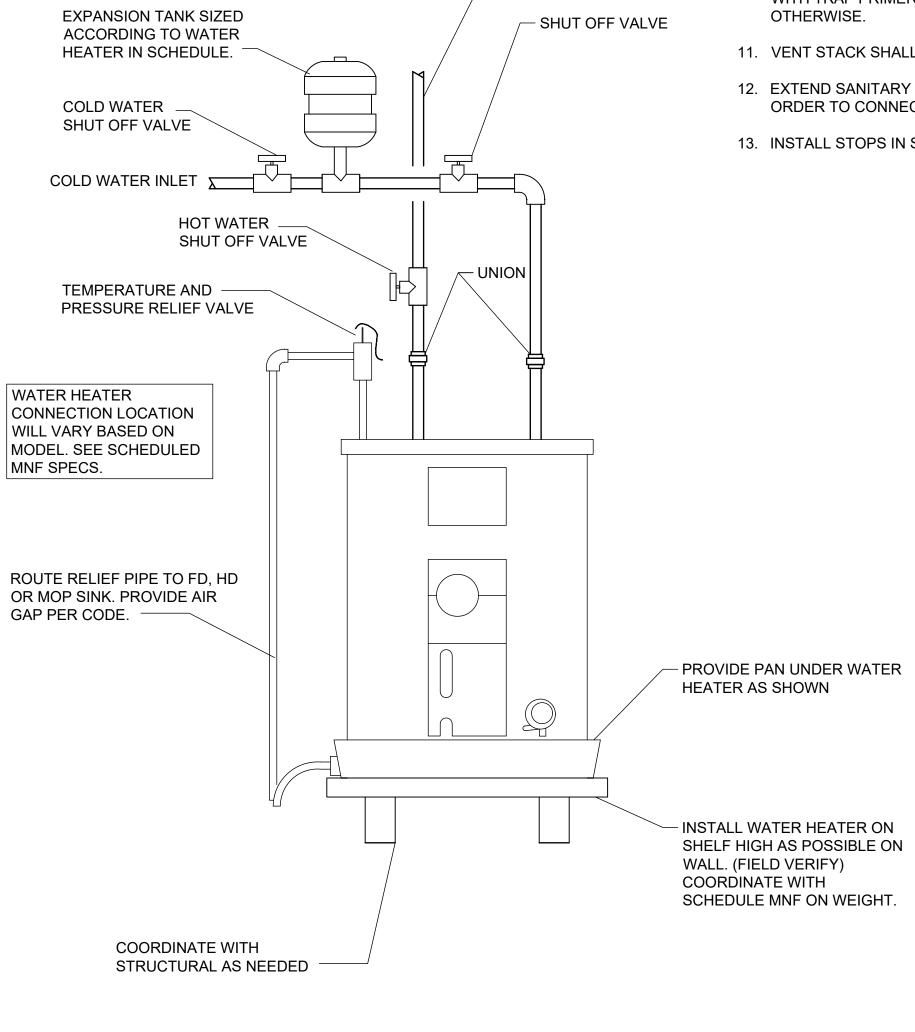

HOT WATER OUTLET

SHELF WATER HEATER DETAIL

FD / HD / MOP

- 14. INSTALL SHUT-OFF VALVES AT ALL EQUIPMENT.
- 15. PROVIDE VENTS, CLEANOUTS, AND PLUMBING AS REQ'D BY STATE PLUMBING CODE.
- 16. PIPING SHALL BE CONCEALED IN FINISHED AREAS. UNLESS NOTED OTHERWISE.
- 17. CONTRACTOR SHALL VERIFY DIMENSIONS BEFORE STARTING WORK.
- 18. ALL EQUIPMENT INSTALLED AS PER CERTIFIED SHOP DRAWING FROM MFR.
- 20. PROVIDE HYDRAULIC SHOCK ABSORBERS WHERE QUICK-CLOSING VALVES ARE UTILIZED AND AS OTHERWISE REQUIRED BY CODE.
- 21. ROOF OPENINGS SHALL MEET ROOF BOND CANTS AND FLASHINGS BY ROOFING CONTRACTOR. ALL COLLARS ON VENTS, ETC. BY ROOFING CONTRACTOR.
- 22. HOSE BIBBS & WALL HYDRANTS SHALL BE A MIN. OF 18" ABOVE FR. GRADE.
- 23. ALL EXTERIOR EXPOSED GAS PIPING TO BE PAINTED WITH WATER PROOF PAINT. COORDINATE WITH ARCHITECT ON COLOR.
- 27. PIPING PENETRATING FIRE RATED WALLS SHALL HAVE UL FIRE RATED CAULKING
- 28. C-CLAMPS ARE NOT TO BE USED WITHOUT A SEISMIC RETAINER STRAP ON ANY PROJECTS LOCATED WITHIN A SEISMIC ZONE.
- 30. NO PIPING SHALL BE RUN DIRECTLY OVER ANY ELECTRICAL PANELS, TRANSFORMERS, SWITCHGEAR ETC.
- 31. WHEN BRANCH LINE EXCEEDS 20FT IN LENGTH, AN ADDITIONAL WATER HAMMER ARRESTER SHOULD BE INSTALLED, USING BRANCH LINE PIPE SIZE, AT THE END OF THE BRANCH LINE BETWEEN THE LAST TWO FIXTURES. WATER HAMMER ARRESTER FOR A BRANCH SERVING A PIECE OF EQUIPMENT WITH A QUICK-CLOSING VALVE SHOULD BE PLACED AS CLOSE AS POSSIBLE TO THE EQUIPMENT ISOLATIO

FIXTURE CONNECTION SCHEDULE

DECODIDITION	CONNECTION SIZE							
DESCRIPTION	WASTE	C.W.	H.W.	VENT				
SINK	2"	1/2"	1/2"	1-1/2"				
URINAL	2"	3/4"	-	1-1/2"				
LAVATORY (TOILET/ADA)	2"	1/2"	1/2"	1-1/2"				
WATER CLOSET (TANK TYPE)	3"	3/4"	-	1-1/2"				
WATER CLOSET (FLUSH VALVE)	3"	1-1/2"	-	1-1/2"				
SHOWER	3"	3/4"	3/4"	1-1/2"				
MOP BASIN	3"	1/2"	1/2"	1-1/2"				
DRINKING FOUNTAIN	2"	1/2"	-	1-1/2"				
FLOOR DRAIN	3" OR 4"	1/2" T.P.	-	1-1/2"				
TRAP PRIMER UNIT	-	1/2"	-	-				
NOTE: FIXTURE CONNECTION SCHEDULE SHALL BE USED FOR TYPICAL CONNECTION								

NOTE: FIXTURE CONNECTION SCHEDULE SHALL BE USED FOR TYPICAL CONNECTION. SEE RISER AND PLANS FOR ADDITIONAL WASTE, CW, HW, AND VENT SIZES.

(P-2) ADA ADA PROVIDE OPEN FRONT TOILET SEAT TO MATCH EQUIPMENT IF NOT INCLUDED. PROVIDE ALL ACCESSORIES FOR COMPLETE UNIT INSTALLATION. WATER HEATER BASED ON AO SMITH MODEL #DEL-20. 19 GALLON CAPACITY TANK WITH 2KW SIMULATANEOUS HEATING ELEMENT, INPUT HEAT AT 240V. PROVIDE ANY ADDITIONAL	PLUMBING FIXTURE SCHEDULE								
(P-1) PROVIDE AND INSTALL BATH/SHOWER VALVE TRIM KIT MODEL #K-TS45106-4G-CP. (P-2) TANK TYPE ADA KOHLER MODEL NUMBER K-25077. 1.28 GPF TANK TYPE TOILET WITH A 3" DRAIN. PROVIDE OPEN FRONT TOILET SEAT TO MATCH EQUIPMENT IF NOT INCLUDED. PROVIDE ALL ACCESSORIES FOR COMPLETE UNIT INSTALLATION. (P-3) WATER HEATER BASED ON AO SMITH MODEL #DEL-20. 19 GALLON CAPACITY TANK WITH 2KW SIMULATANEOUS HEATING ELEMENT, INPUT HEAT AT 240V. PROVIDE ANY ADDITIONAL ACCESSORIES FOR COMPLETE UNIT INSTALLATION. SEE DETAIL. ROUTE WATER HEATER RELIEF	MARK	FIXTURE DESCRIPTION							
(P-2) ADA PROVIDE OPEN FRONT TOILET SEAT TO MATCH EQUIPMENT IF NOT INCLUDED. PROVIDE ALL ACCESSORIES FOR COMPLETE UNIT INSTALLATION. (P-3) WATER HEATER BASED ON AO SMITH MODEL #DEL-20. 19 GALLON CAPACITY TANK WITH 2KW SIMULATANEOUS HEATING ELEMENT, INPUT HEAT AT 240V. PROVIDE ANY ADDITIONAL ACCESSORIES FOR COMPLETE UNIT INSTALLATION. SEE DETAIL. ROUTE WATER HEATER RELIEF	(P-1)								
(P-3) SIMULATANEOUS HEATING ELEMENT, INPUT HEAT AT 240V. PROVIDE ANY ADDITIONAL ACCESSORIES FOR COMPLETE UNIT INSTALLATION. SEE DETAIL. ROUTE WATER HEATER RELIEF									
	(P-3)	SIMULATANEOUS HEATING ELEMENT, INPUT HEAT AT 240V. PROVIDE ANY ADDITIONAL ACCESSORIES FOR COMPLETE UNIT INSTALLATION. SEE DETAIL. ROUTE WATER HEATER RELIEF							
(P-4) GUY GRAY OUTLET BOX MODEL #82139 PROVIDE ANY OTHER ACCESSORIES NEEDED FOR COMPLETE UNIT INSTALLATION.	(P-4)								

NOTE: ALL ABBREVIATIONS N

AFD	AREA FLOOR DRAIN
AFF	ABOVE FINISH FLOOR
AHJ	AUTHORITY HAVING JURISDICTION
ARCH	ARCHITECT
BF	BOTTLE FILLER
BFF	BELOW FINISH FLOOR
BOP	BOTTOM OF PIPE
BTU/H	BRITISH THERMAL UNIT / PER HOUR
CD	CONDENSATE DRAIN
CFM	CUBIC FEET PER MINUTE
СО	CLEAN OUT
CPVC	CHLORINATED POLY VINYL CHLORIDE
CW	COLD WATER
DF	DRINKING FOUNTAIN
DN	DOWN
DTL	DETAIL
DWG	DRAWING
ECO	EXTERIOR CLEAN OUT
EM	EMERGENCY
EQUIP	EQUIPMENT
FD	FLOOR DRAIN
FS	FLOOR SINK
FT HD	FEET OF HEAD
GC	GENERAL CONTRACTOR
GPM	GALLONS PER MINUTE
НВ	HOSE BIBB
HD	HUB DRAIN
НР	HORSE POWER
HW	HOT WATER
HWR	HOT WATER RETURN
HZ	HERTZ
IU	INDOOR UNIT
KW	KILOWATT

MATERIALS

WATER PIPE -

ABOVE SLAB TYPE L COPPER; UNDERGROUND TYPE K COPPER COPPER PIPE FITTINGS SHALL BE WROT COPPER, SOCKET TYPE, MIL-F-1183 WITH 95/5 SOLDER OR "NO LEAD" SOLDER FOR POTABLE WATER DE-BURR ALL PIPE FOR CLEAN FINISH AND USE.

SEWER -

WASTE PIPING BELOW SLAB - SCHEDULE 40 PVC

WASTE AND VENT PIPING ABOVE SLAB CAN BE SCH. 40 PVC PVC PIPE FITTINGS 4" AND SMALLER SHALL BE ASTM D-1785, TYPE 1, GRADE 1, SOCKET TYPE WITH ASTM D-2564 SOLVENT CEMENT.

COMPRESSED AIR -

MAIN PIPING TO BE BLACK STEEL SCHEDULE 40 PIPING DROPS TO BE FLEXIBLE BLUE HOSE MADE FROM PVC WITH STEEL QUICK-CONNECT COUPLINGS (COORDINATE WITH OWNER)

NATURAL GAS -PIPING TO BE BLACK STEEL SCHEDULE 40 OR CARBON STEEL FITTINGS TO BE THREADED UP TO 2" IN DIA AND OVER MUST BE WELDED. OR FITTINGS TO BE CARBON STEEL PRESS-CONNECT AND CONFORM TO ASTM F3226. PRESS CONNECT FITTING SHALL HAVE A FEATURE TO DETECT UNPRESSED FITTINGS SHALL BE INTEGRATED INTO THE BODY OF THE FITTING

SPECIFICATIONS

ALL INTERNAL WATER LINES INSULATED WITH 1" BLACK FOAM

VALVE ASSEMBLIES. FASTENERS SHALL BE NYLON-TYPE

ALL ABOVE GROUND PIPING TO BE STENCILED EVERY 10'-0" HANDICAP LAVATORY P-TRAP AND ANGLE VALVE ASSEMBLIES SHALL BE INSULATED WITH THE FULLY MOLDED, TRUEBRO, HANDI LAV-GUARD INSULATION KIT WITH 3-PIECE INTERLOCKING TRAP ASSEMBLY AND 2-PIECE INTERLOCKING ANGLE

HANDI LAV-GUARD KIT FITS:


- 1 1/4" OR 1 1/2" TUBULAR PLASTIC P-TRAPS
- 1 1/4" OR 1 1/2" TUBULAR BRASS P-TRAPS
- 1 1/4" OR 1 1/2" SEMI-CAST BRASS P-TRAPS
- 1 1/4" STRAIGHT LAVATORY TAIL PIECE
- 1/2" SWEAT ANGLE STOP VALVE, KEYED OR REGULAR 1/2" COMP. ANGLE STOP VALVE, KEYED OR REGULAR
- 3/8" I.P. ANGLE STOP VALVE, KEYED OR REGULAR 3/8" 0.D. SUPPLY TUBE


PLUMBING ABBREVIATION LEGEND

ΛA	Y NOT APPLY	
	LAV	LAVATORY
	LB	POUND
	MBH	THOUSAND BTU'S PER HOUR
	MFR	MANUFACTURER
	MIN	MINIMUM
	NG	NATURAL GAS
	NIC	NOT IN CONTRACT
	NTS	NOT TO SCALE
	OR	OPEN RECEPTACLE
	PEX	CROSS-LINKED POLYETHYLENE
	РК	PACKAGED UNIT
	PRV	PRESSURE REDUCING VALVE
	PSI	PRESSURE PER SQUARE INCH
	PVC	POLY VINYL CHLORIDE
	RTU	ROOF TOP UNIT
	RPZ	REDUCED PRESSURE ZONE ASSEMBLY
	SAN. SEWER	SANITARY SEWER
	SHW	SHOWER
	SPEC	SPECIFICATION
	SQ FT	SQUARE FOOT
	SQ IN	SQUARE INCH
	SS	STAINLESS STEEL / SAN. SEWER
	TD	TRENCH DRAIN
	TDH	TOTAL DYNAMIC HEAD
	ТН	TUBE HEATER
	ТҮР	TYPICAL
	UH	UNIT HEATER
	UR	URINAL
	V	VENT
	VTR	VENT THRU ROOF
	W/	WITH
	WC	WATER CLOSET / WATER COLUMN
	WCO	WALL CLEAN OUT
	WH	WALL HYDRANT



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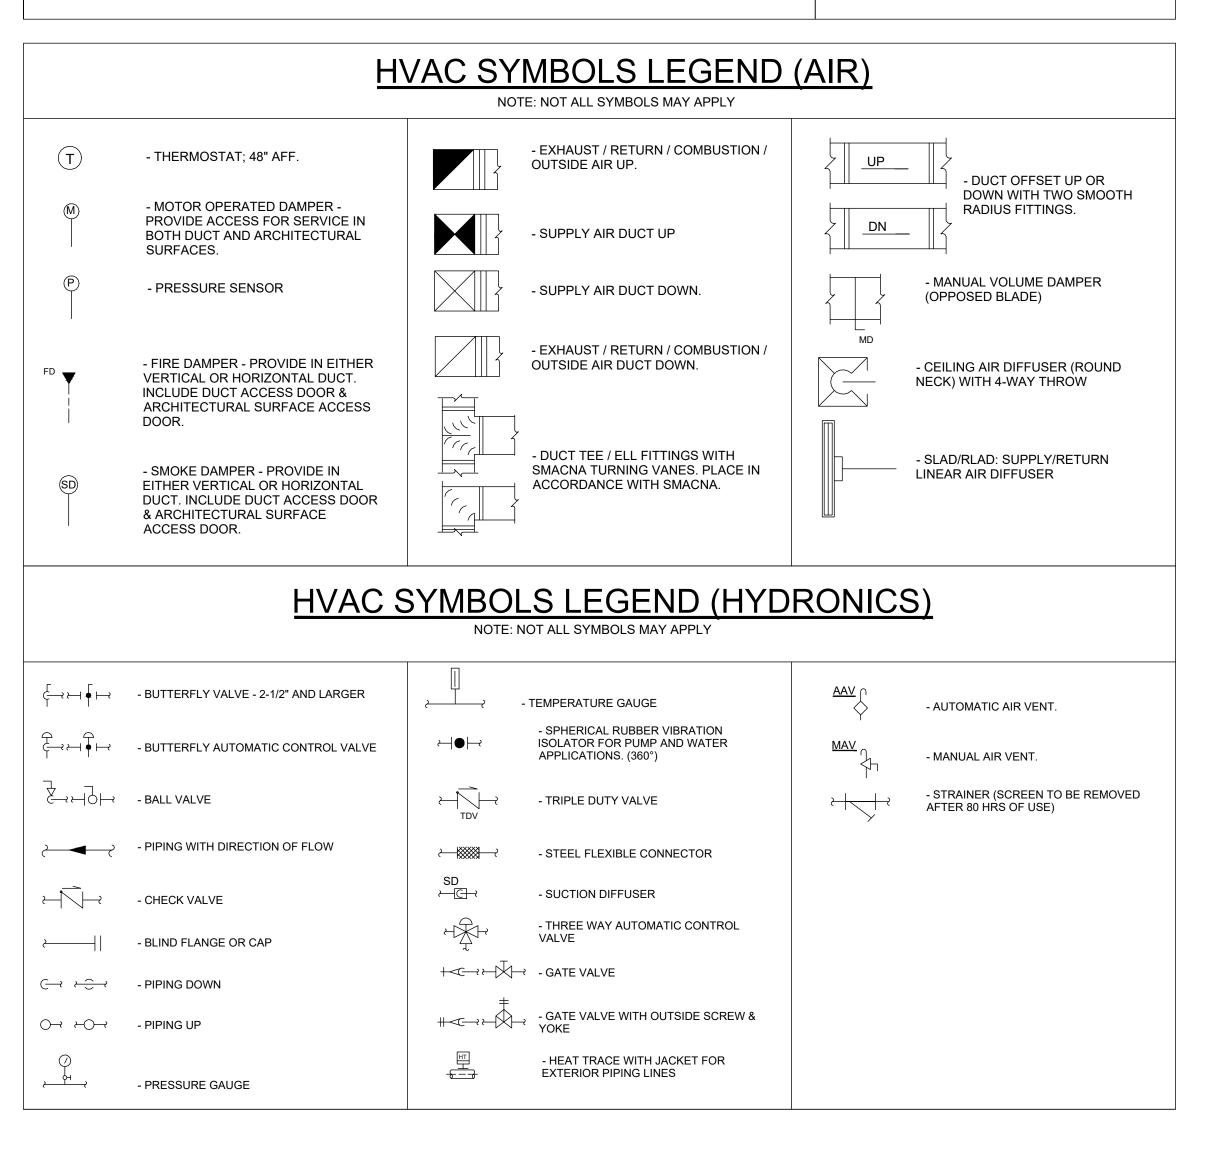
P-1.3

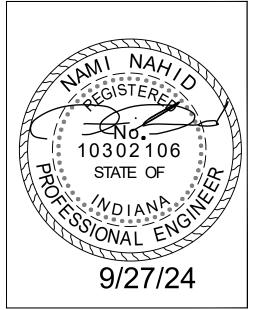HVAC ABBREVIATION LEGEND

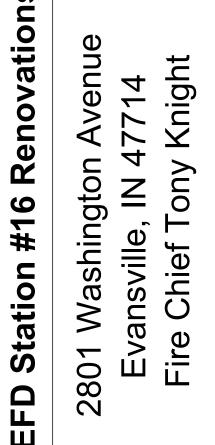HYDRONIC

NOTE: ALL ABBREVIATIONS MAY NOT APPLY

GENERAL/AIR



GENERAL NOTES:

1. ALL WORK SHALL BE DONE BY LICENSED CONTRACTOR.

TRADES THROUGH THE GENERAL CONTRACTOR.

- 2. THE CONTRACTOR SHALL BE RESPONSIBLE FOR JOBSITE SAFETY, INCLUDING REQUIREMENTS OF AUTHORITIES HAVING JURISDICTION.
- 3. COORDINATE WORK AND SCHEDULES WITH OWNER, PROJECT MANAGER, OTHER CONTRACTORS AND APPROPRIATE UTILITY COMPANIES.
- 4. ALL WORK SHALL COMPLY WITH THE REQUIREMENTS OF THE CONTRACT DOCUMENTS INCLUDING ADDENDA, APPLICABLE CODES AND STANDARDS.
- 5. CONTRACTOR SHALL INCLUDE ALL MATERIALS, LABOR, TOOLS, ETC. FOR A COMPLETE OPERABLE INSTILLATION. ALL MATERIALS SHALL BE NEW, SPECIFICATION GRADE AND UL LISTED UNLESS OTHERWISE NOTED.
- 6. PROVIDE ONE YEAR WARRANTY FOR ALL WORKMANSHIP AND MATERIALS AFTER THE DATE OF FINAL ACCEPTANCE.
- PRIOR TO START OF WORK, SUBMIT SHOP DRAWINGS FOR ALL MECHANICAL EQUIPMENT, PLUMBING FIXTURES AND DIFFUSERS.
- 8. ALL CONSTRUCTION DEBRIS SHALL BE DISPOSED OF IN PROPER MANNER. ALL EQUIPMENT REMOVED SHALL BE DISPOSED, COORDINATE WITH OWNER FOR ANY ITEMS THEY MAY REQUEST.
- 9. THERE SHALL BE NOTHING ABANDONED IN PLACE UNLESS NOTED. 10. ALL TRADES SHALL COORDINATE THE INSTALLATION AND ROUTING OF THEIR WORK WITH OTHER
- 11. LOCATE DUCTWORK, PIPING AND MECHANICAL EQUIPMENT AWAY FROM THE SPACE ABOVE ELEC PANELS, TRANSFORMERS AND OTHER ELECTRICAL EQUIPMENT.
- 12. CONTRACTOR SHALL VISIT SITE TO VERIFY ALL EXISTING CONDITIONS THAT MAY AFFECT WORK FIELD VERIFY ALL EXISTING CONDITIONS PRIOR TO BID.
- 13. STORE MATERIALS AS DIRECTED. PROTECT STORED MATERIALS AND INSTALLED FROM DAMAGE.
- 14. REMOVE DIRT, DEBRIS AND ANY UNUSED MATERIAL FROM JOBSITE REGULARLY AND DISPOSE OF BY PROPER LEGAL METHODS.
- 15. PATCH AND FINISH CONSTRUCTION DAMAGE DURING THE COURSE OF HVAC INSTALLATION. PROVIDE PROPER SEALS AT ALL WALLS AND ROOF PENETRATIONS.
- 16. PERFORM TESTING AND MAKE FINAL ADJUSTMENTS TO VERIFY PERFORMANCE OF ALL SYSTEMS AND EQUIPMENT.
- 17. MAINTAIN "AS BUILTS" RECORD DRAWINGS OF ALL INSTALLED ITEMS AND PROVIDE TO PROJECT MANAGER AT COMPLETION OF PROJECT.
- 18. CONTRACTOR TO INCLUDE REQUIRED EXTENDED WORK HOURS, WEEKENDS AND HOLIDAY OVERTIME FOR DISCONNECTION AND/OR TIE INS OF UTILITY SYSTEMS REQUIRING ISOLATION AND/OR SHUT DOWNS OF THE OWNERS SYSTEMS.
- 19. ALL WORK SHALL BE COORDINATED WITH PROJECT PHASING REQUIREMENTS.
- 20. ALL PENETRATIONS IN FIRE RATED AND SMOKE RATED ASSEMBLIES SHALL BE PROPERLY FIRE STOPPED PER UL LISTED STANDARD.
- 21. PROVIDE SLEEVES AND OR OPENINGS TO RUN PIPES AND DUCTWORK THROUGH FOUNDATIONS, WALLS, AND ROOF.
- 22. MAINTAIN CLEAR ACCESS TO SERVICE EQUIPMENT AND OTHER ACCESSORIES REQUIRING SERVICE. VISUAL INSPECTION, OR HAND OPERATION. WHERE INDICATED OR REQUIRED, PROVIDE ACCESS PANELS OF THE TYPE SELECTED TO SUIT MATERIALS IN WHICH INSTALLED.
- 23. ADJUST PIPING AND DUCTWORK SIZES TO PROPERLY CONNECT TO MECHANICAL EQUIPMENT. 24. ALL THERMOSTATS SHALL BE MOUNTED AT 48" AFF. UNLESS OTHERWISE NOTED. IF OTHER
- SWITCHES ARE IN SAME LOCATION, MOUNT THERMOSTAT AT SAME LEVEL AS OTHER SWITCHES.
- 25. ALL MECHANICAL EQUIPMENT INSTALLED SHALL BE INSTALLED TO MANUFACTURES RECOMMENDATIONS FOR CLEARANCES.
- 26. PROVIDE TURNING VANES IN ALL DUCTWORK.
- 27. ALL OPENINGS IN PRECAST SLAB STRUCTURES TO BE COORDINATED WITH MANUFACTURE OF PRE CAST SLAB PRIOR TO CONSTRUCTION. ANY DRILLING OF HOLES OR CUTTING OPENINGS TO BE APPROVED BY PRE CAST SLAB PROVIDER AND STRUCTURAL ENGINEER PRIOR TO DRILLING.
- 28. LOCATION OF PIPING, DUCTOWRK, AND EQUIPMENT AS INDICATED ON THE DRAWING, ARE APPROXIMATE AND SUBJECT TO MINOR ADJUSTMENTS IN THE FIELD. WORK SHALL BE COORDINATED WITH ALL OTHER TRADES TO AVOID INTERFERENCES.
- 29. INSTALL ALL EXPOSED PIPING AND DUCTWORK AS HIGH AS POSSIBLE IN ROOMS WITHOUT CEILINGS.
- 30. CONDENSATE DRAINS SHALL BE SUPPLIED FOR ALL COOLING EQUIPMENT. CONTRACTOR SHALL ENSURE PROPER INSTALLATION AND DRAINAGE AS REQUIRED BY FEDERAL, STATE, AND LOCAL CODES.
- 31. COORDINATE THE EXACT LOCATION OF DIFFUSERS AND RETURN GRILLES WITH THE LOCATION OF SPRINKLER HEADS, LIGHTS AND OTHER CEILING DEVICES
- 32. DRAWINGS ARE DIAGRAMMATIC IN NATURE AND ALL SPECIFIC ROUTING ELEMENTS ARE NOT INCLUDED FOR CLARITY OF DRAWINGS. THE DRAWINGS MUST BE EXAMINED FULLY IN CONJUNCTION WITH ALL OTHER DISCIPLINES TO IDENTIFY ROUTING PATHS AND ELEMENTS.
- 33. ALL EXPOSED REFRIGERANT PIPING SHALL BE INSTALLED WITH HIDE A PIPE SYSTEM. EXTERIOR AND INTERIOR PIPING TO RECIEVE PIPING COVERS OVER ALL EXPOSED PIPING. COLOR TO BE SELECTED BY ARCHITECT. SIZE COVER BASED ON NUMBER OF PIPES.



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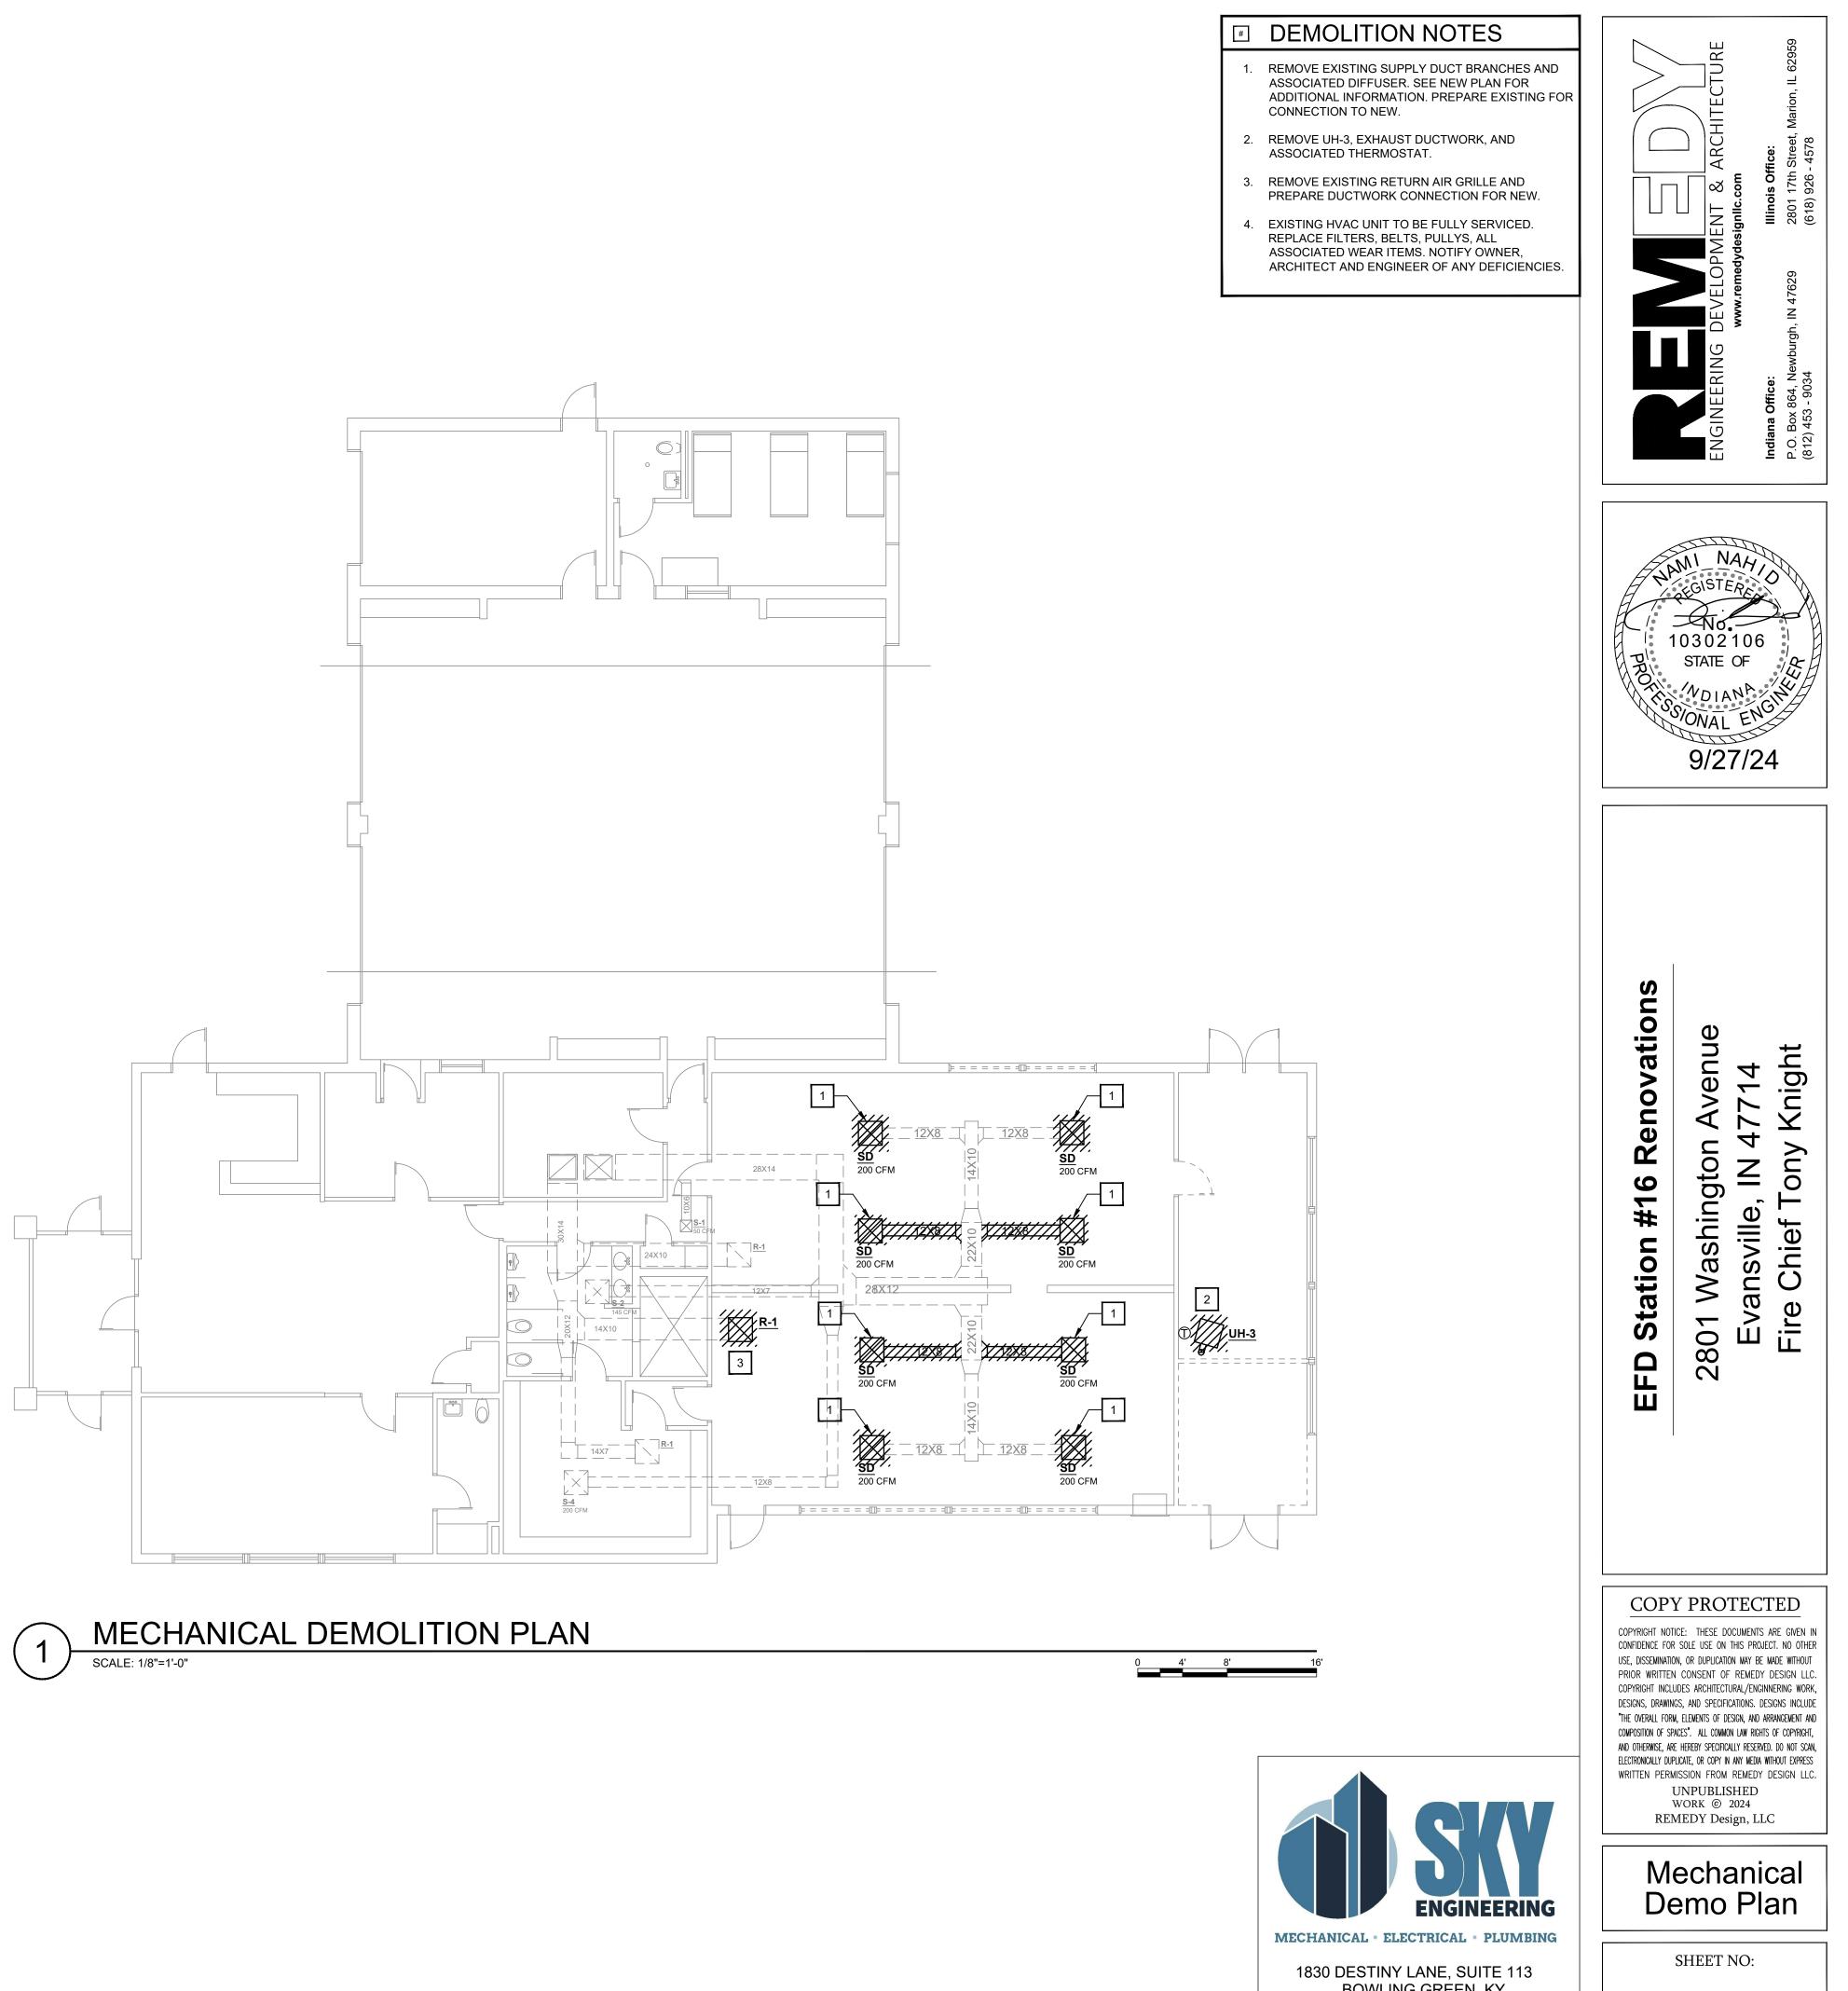
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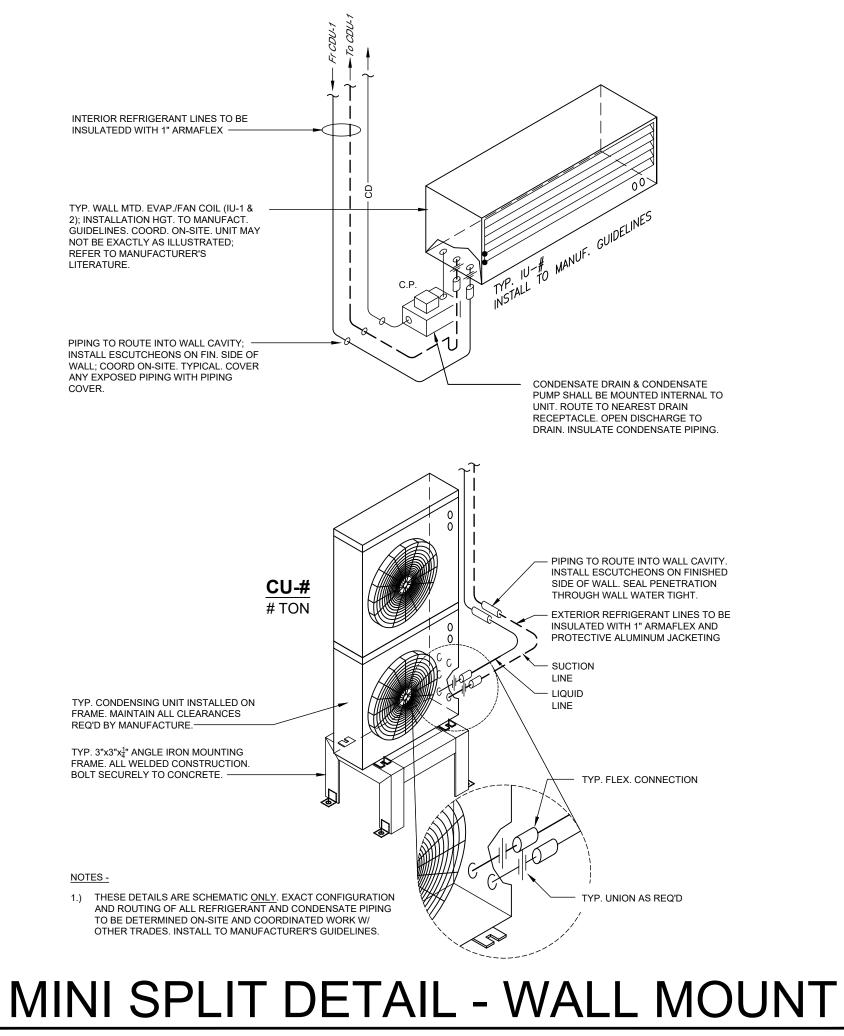
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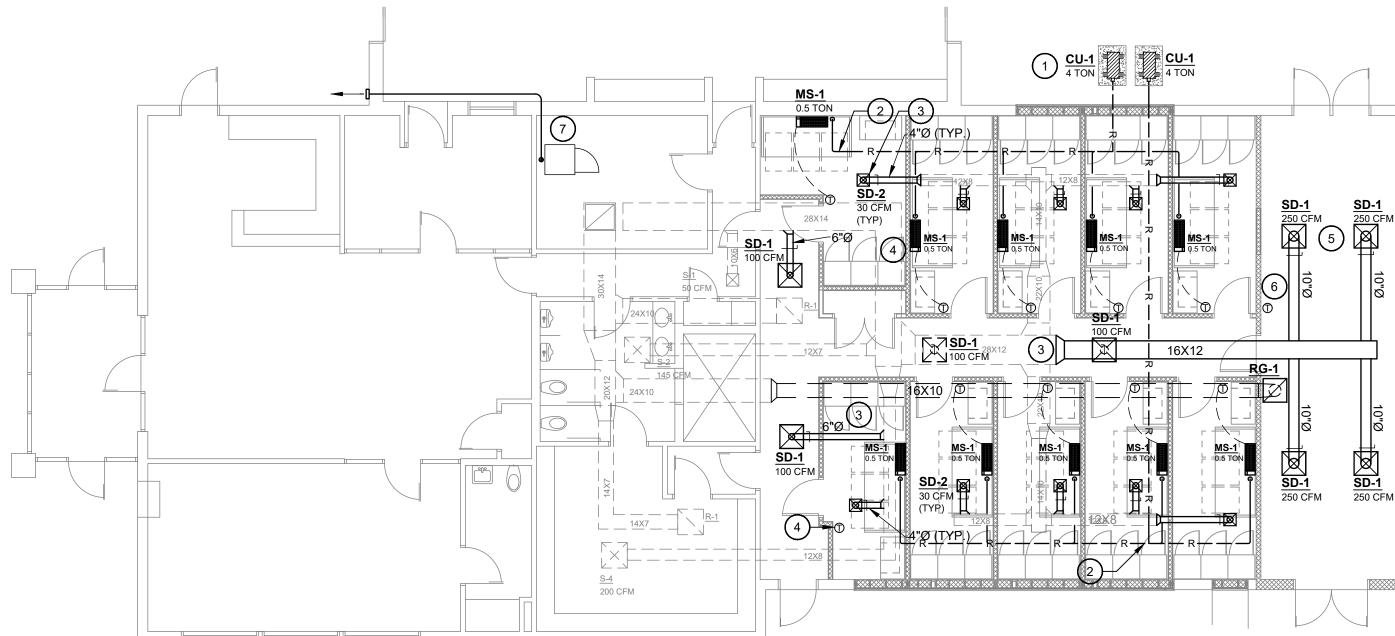


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M-1.0



NOT TO SCALE





CU-1/MS-1 MODEL: DAIKIN MS-1: CTXS07LVJU OUTDOOR UNIT:

CU-1: 5MXS48TVJU VOLTAGE: 208-230 / 1PH / 60 MCA: 33.2 AMPS MCB: 35 AMPS NOTES:

DISCONNECT AT UNIT. PROGRAMMABLE THERMOSTAT, AT INDICATED LOCATIONS. DRG SD-1

24"X24" SQUARE CONE, OFF-WHITE, CEILING / LAY-IN SD-2 NOTES:


RG-1 BASED ON PRICE MODEL 80

LOW PRESSURE SYSTEM. BARRIER WRAP. TIGHT

PREVENT WATER BUILD UP.

DRAIN PIPING SINK

VERIFY EXISTING CONDITIONS.

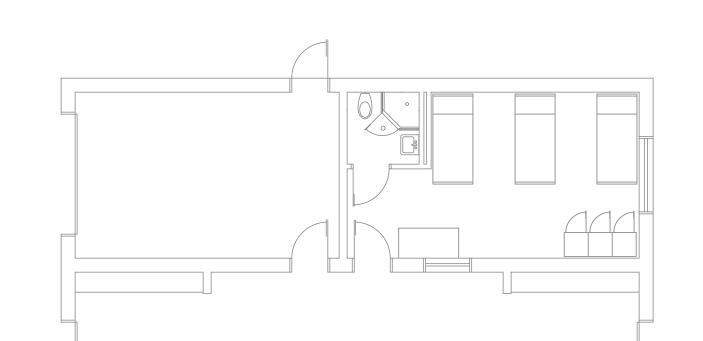

MECHANICAL FLOOR PLAN

SCALE: 1/8"=1'-0"

0 4' 8'

EQUIPMENT SCHED.

MINI-SPLIT SYSTEMS

WALL MOUNT HEAT PUMP COOLING CAPACITY: 0.5 TON HEATING OUTPUT: 7,000 BTUh

1) ELECTRICAL CONTRACTOR TO PROVIDE A MEANS OF 2) PROVIDE AND INSTALL WALL MOUNTED.

- 12"X12" SQUARE CONE, OFF-WHITE, CEILING / LAY-IN
- 1) BASED ON PRICE MODEL ASCD 2) PROVIDE COVER INSULATION OVER DIFFUSER 3) PROVIDE W/ OPTIONAL STEEL-OPPOSED BLADE DAMPER
- 24"X24" EGGCRATE, OFF-WHITE, CEILING / LAY-IN
- DUCTWORK AND AIR DEVICES INSULATION DUCTWORK AS PER LATEST SMACNA GUIDELINES FOR INSULATED ALL (SUPPLY, RETURN, EXHAUST, OUTSIDE
- AIR) WITH FIBERGLASS INSULATION (R-8) AND VAPOR ALL DIFFUSERS AND GRILLES SHALL HAVE ABOVE DIFFUSER MOLDED INSULATION ON FACE PLATES. INSULATE ALL EXPOSED OUTSIDE DUCTWORK WITH 1"
- (R-8) DUCKBOARD WITH ALUMINUM COVER. SEAL WATER PROVIDE SLOPE ON TOP OF ALL DUCTWORK TO
- UNITS SHALL HAVE PVC CONDENSATE DRAIN PIPING ROUTED TO CONDENSATE MAIN, FLOOR DRAIN, OR JAN.
- SLOPE PIPING FOR GRAVITY DRAIN, IF POSSIBLE. PROVIDE PUMP FOR COND. LINE, AS REQUIRED. FIELD
- INSULATE CONDENSATE LINE WITH 3/4" ARMAFLEX INSULATION THROUGHOUT, TO DRAIN POINT LOCATION.


- **GENERAL NOTES:**
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- OF BY THE CONTRACTOR, UNLESS NOTES OTHERWISE.
- 4. THERE SHALL BE NOTHING ABANDONED IN PLACE, UNLESS SPECIFICALLY IDENTIFIED AS SUCH
- 5. ALL WORK SHALL COMPLY WITH THE REQUIREMENTS OF THE CONTRACT DOCUMENTS, INCLUDING ADDENDA, AND APPLICABLE CODES AND STANDARDS.
- 6. ALL TRADES SHALL COORDINATE THE ROUTING AND INSTALLATION OF HIS WORK WITH THAT OF ALL OTHER TRADES THROUGH THE GENERAL CONTRACTOR.
- 7. PROVIDE ALL EQUIPMENT, MATERIAL, LABOR, SUPERVISION, COST, AND SERVICES REQUIRED TO INSTALL COMPLETE AND WORKING SYSTEMS. INCLUDING ALL ITEMS AND APPURTENANCES NECESSARY, REASONABLE, INCIDENTAL, OR CUSTOMARILY INCLUDED, EVEN THOUGH EACH AND EVERY ITEM IS NOT SPECIFIED OR SHOWN.


MECH. NOTES:

- PROVIDE AND INSTALL NEW MINI-SPLIT CONDENSING UNITS ON NEW EQPT STAND. ROUTE REFRIGERANT PIPING UP EXTERIOR WALL. INSTALL HIDE A PIPE SYSTEM OVER ALL EXPOSED REFRIGERANT PIPING.
- ROUTE REF. PIPING FROM CONDENSING UNIT TO ASSOCIATED INDOOR UNIT. INSULATE REF. PIPE LINE WITH 3/4" BLACK FOAM. INSTALL HIDE A PIPE SYSTEM OVER ALL EXPOSED REFRIGERANT PIPE. SEAL ANY OPENINGS WATER TIGHT. PROVIDE PIPE SUPPORT, AS REQUIRED BY MANUFACTURER. ROUTE CONDENSATE LINE TO NEAREST DRAIN POINT. (TYP.)
- ROUTE NEW SUPPLY/RETURN DUCTWORK FROM EXISTING DUCTWORK TO NEW CEILING DIFFUSERS.
- PROVIDE & INSTALL WIFI-READY DIGITAL THERMOSTAT FOR HVAC SYSTEM. (TYP.)
- INSTALL MANUAL DAMPER IN EACH SUPPLY BRANCH. BALANCE ACCORDING TO FLOW. TYPICAL FOR ALL CEILING DIFFUSERS. (TYP.)
- RELOCATE EXISTING THERMOSTAT FOR CONTROL OF AHU-2.
- PROVIDE & INSTALL WALL MOUNTED DRYER DUCT CONNECTION BOX. ROUTE 4Ø RIGID DUCTWORK THROUGH UP TO ABOVE CEILING LEVEL AND INTO APPARATUS BAY. ROUTE THROUGH SIDEWALL DRYER DISCHARGE CAP. COORDINATE FINISH WITH ARCHITECT.



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SHEET NO:

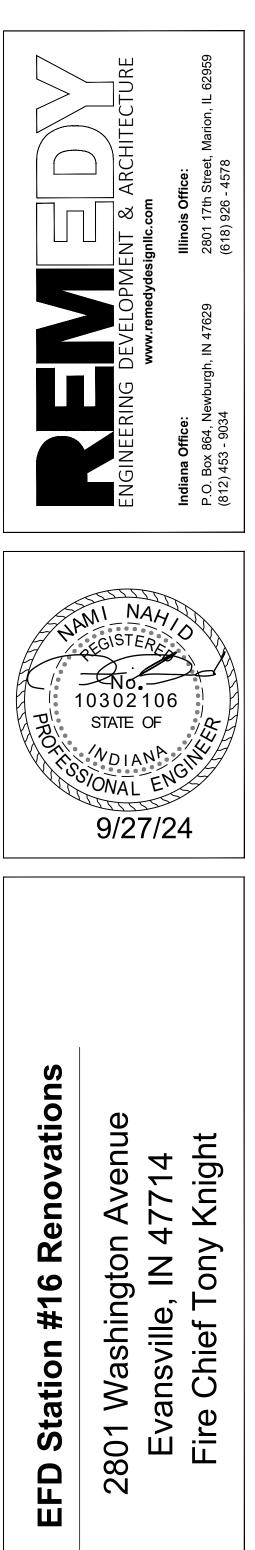

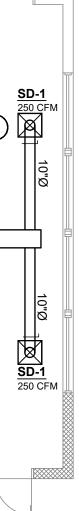ELECTRICAL LEGEND - LIGHTING

ELECTRICAL LEGEND - POWER

SYMBOL	DESCRIPTION CEILING OUTLET AND LIGHTING FIXTURE AS SCHEDULED.	SYMBOL	<u>DESCRIPTION</u> WALL OUTLET WITH 20A, 125V TO TO CENTER, UNLESS NOTE
	CEILING OUTLET AND LIGHTING FIXTURE AS SCHEDULED.		
○ ⊢⊖	CEILING OUTLET AND LIGHTING FIXTURE AS SCHEDULED. REMOTE HEAD, CONTROLLED BY EXIT LIGHT.		WALL OUTLET WITH 20A, 125V TO CENTER, OR 8 INCHES ABC NOTED OTHERWISE.
€,	CEILING OUTLET AND LIGHTING FIXTURE AS SCHEDULED.		CEILING MOUNTED OUTLET WI
k⊗ €₽	WALL OUTLET AND LIGHTING FIXTURE AS SCHEDULED. WALL MOUNTED EMERGENCY LIGHT AS SCHEDULED.	-	WALL OUTLET WITH 20A, 125V FINISHED FLOOR TO CENTER,
A	WALL OUTLET AND LIGHTING FIXTURE AS SCHEDULED.		WALL OUTLET WITH 20A, 125V
	SYMBOL INDICATES FIXTURE TYPE WHEN SHOWN ON LIGHTING PLANS ADJACENT TO FIXTURE SYMBOL. REFER TO LIGHTING FIXTURE SCHEDULE FOR FIXTURE REQUIREMENTS.	-	FINISHED FLOOR TO TO CENTE CENTER, UNLESS NOTED OTH
S	OUTLET BOX AND 20-AMP, SINGLE-POLE SWITCH. MOUNT AT 46 INCHES ABOVE FINISHED FLOOR	÷	WALL OUTLET WITH SIMPLEX F
S _a	TO CENTER, UNLESS NOTED OTHERWISE. LOCATE WITHIN 12 INCHES OF STRIKE SIDE OF DOOR, UNLESS NOTED OTHERWISE. SUB-TEXT INDICATES CIRCUIT SWITCHED.	€	WALL OUTLET WITH 2 POLE, 25 EQUIPMENT BEING SERVED. N SERVED.
S _{3a}	OUTLET BOX AND 20-AMP, THREE-WAY SWITCH. MOUNT AT 46 INCHES ABOVE FINISHED FLOOR TO CENTER, UNLESS NOTED OTHERWISE. LOCATE WITHIN 12 INCHES OF STRIKE SIDE OF DOOR, UNLESS NOTED OTHERWISE. SUB-TEXT INDICATES CIRCUIT SWITCHED.		FLOOR OUTLET WITH 125V, 20/ VOLTAGE BARRIER.
S _{4a}	OUTLET BOX AND 20-AMP, FOUR-WAY SWITCH. MOUNT AT 46 INCHES ABOVE FINISHED FLOOR TO CENTER, UNLESS NOTED OTHERWISE. LOCATE WITHIN 12 INCHES OF STRIKE SIDE OF DOOR, UNLESS NOTED OTHERWISE. SUB-TEXT INDICATES CIRCUIT SWITCHED.	ØØ	FLOOR OUTLET WITH 125V, 20/ WITH LOW VOLTAGE BARRIER
	OUTLET BOX AND 20-AMP, SINGLE-POLE DIMMER SWITCH. MOUNT AT 46 INCHES ABOVE FINISHED	GFCI	SYMBOL INDICATES GROUND ADJACENT TO RECEPTACLE S
S ^D _a	FLOOR TO CENTER, UNLESS NOTED OTHERWISE. LOCATE WITHIN 12 INCHES OF STRIKE SIDE OF DOOR, UNLESS NOTED OTHERWISE. SUB-TEXT INDICATES CIRCUIT SWITCHED.	WP	SYMBOL INDICATES WEATHER ENCLOSURE WHEN SHOWN AD
S ^{3D} _a	OUTLET BOX AND 20-AMP, THREE-WAY DIMMER SWITCH. MOUNT AT 46 INCHES ABOVE FINISHED FLOOR TO CENTER, UNLESS NOTED OTHERWISE. LOCATE WITHIN 12 INCHES OF STRIKE SIDE OF DOOR, UNLESS NOTED OTHERWISE. SUB-TEXT INDICATES CIRCUIT SWITCHED.	USB	SYMBOL INDICATES USB WALL SHOWN ADJACENT TO RECEP PROTECTION AS NECESSARY.
ത്ര	OUTLET BOX AND 20-AMP, COMBINATION SWITCH AND OCCUPANCY SENSOR. MOUNT AT 46 INCHES ABOVE FINISHED FLOOR TO CENTER, UNLESS NOTED OTHERWISE. LOCATE WITHIN 12	TV	SYMBOL INDICATES TV LOCAT PROVIDE AND INSTALL A DATA JACK AND RECEPTACLE AT 18
® S×x	INCHES OF STRIKE SIDE OF DOOR, UNLESS NOTED OTHERWISE. OTHER TEXT INDICATES SWITCH CONFIGURATION AND CIRCUIT SWITCHED AS OTHER NON-OCCUPANCY SENSOR SWITCHES.	1,3,5,	NUMBER TEXT INDICATES CIR
	OUTLET BOX AND 10-AMP, COMBINATION SWITCH AND LOW-VOLTAGE (0-10V) DIMMER. MOUNT AT 46 INCHES ABOVE FINISHED FLOOR TO CENTER, UNLESS NOTED OTHERWISE. LOCATE WITHIN 12	a,b,c,	LOWER-CASE LETTER TEXT IN WITHIN OR ADJACENT TO SYM
S _{XxD}	INCHES OF STRIKE SIDE OF DOOR, UNLESS NOTED OTHERWISE. OTHER TEXT INDICATES SWITCH CONFIGURATION AND CIRCUIT SWITCHED AS OTHER NON-DIMMER SWITCHES.	+48"	NUMBER TEXT INDICATES MOU BOX WHEN SHOWN ADJACENT
		нŴ	WALL-MOUNT JUNCTION BOX
	CEILING-MOUNT OCCUPANCY SENSOR. THE LETTER(S) DESIGNATION ADJACENT TO THE SYMBOL (IF SHOWN) INDICATE SWITCHING ZONES TO BE CONTROLLED BY THE SENSOR. IF A LETTER DESIGNATION IS NOT SHOWN, THE SENSOR SHALL CONTROL ALL LIGHTING FIXTURES WITHIN THE		CEILING-MOUNT JUNCTION BC
(O) _a	ROOM.	HPB	JUNCTION BOX WITH PHOTO E WALL-MOUNT PUSH BUTTON F
Q a,b,c	WALL-MOUNT OCCUPANCY SENSOR. THE LETTER(S) DESIGNATION ADJACENT TO THE SYMBOL (IF SHOWN) INDICATE SWITCHING ZONES TO BE CONTROLLED BY THE SENSOR. IF A LETTER	30A/3 NEMA 3R 🗁	NON-FUSIBLE DISCONNECT SW
Ÿ	DESIGNATION IS NOT SHOWN, THE SENSOR SHALL CONTROL ALL LIGHTING FIXTURES WITHIN THE ROOM.	30A/3 NEMA 3R	FUSIBLE DISCONNECT SWITCH
ELEC	TRICAL LEGEND - FIRE ALARM	30A/3 NEMA 3R	MOTOR STARTER, DISCONNEC RATINGS.
	DESCRIPTION	PHASE CONDUCTOR7	
SYMBOL E s	DESCRIPTION CEILING MOUNT SMOKE DETECTOR.		CIRCUIT. NUMBER OF CROSSE CONDUIT SIZE SHALL BE 3/4 IN
E	MANUAL PULL STATION.		
Ê	WALL MOUNT AUDIO-VISUAL NOTIFICATION DEVICE.	NEUTRAL	
	WALL MOUNT VISUAL-ONLY NOTIFICATION DEVICE.	LP1-1,3,5	HOME RUN TO PANEL. NUMBE
V		.xc.	
∇ E	WALL MOUNT AUDIO-ONLY NOTIFICATION DEVICE.	, F	
Œ	WALL MOUNT AUDIO-ONLY NOTIFICATION DEVICE. CEILING MOUNT VISUAL-ONLY NOTIFICATION DEVICE.		
æ Ø			TRICAL LEG
ഥ る 圣	CEILING MOUNT VISUAL-ONLY NOTIFICATION DEVICE.	ELEC <u>Symbol</u>	DESCRIPTION VOICE/DATA OUTLET. MOUNT ADJACENT RECEPTACLE IF PR
€ E E E	CEILING MOUNT VISUAL-ONLY NOTIFICATION DEVICE. CEILING MOUNT AUDIO-ONLY NOTIFICATION DEVICE.		DESCRIPTION VOICE/DATA OUTLET. MOUNT
© ₽ ₽ E ₽ E	CEILING MOUNT VISUAL-ONLY NOTIFICATION DEVICE. CEILING MOUNT AUDIO-ONLY NOTIFICATION DEVICE. CEILING MOUNT AUDIO-VISUAL NOTIFICATION DEVICE. SMOKE DETECTOR WITH A 520MHZ SOUNDER BASE. CEILING MOUNT HEAT DETECTOR.	<u>SYMBOL</u>	DESCRIPTION VOICE/DATA OUTLET. MOUNT ADJACENT RECEPTACLE IF PR TO CENTER, UNLESS NOTED C OUTLET BOX TO NEAREST ACC SHALL BE 4 INCH SQUARE BY 2 NOTED OTHERWISE. "W" TEXT AT 56 INCHES A.F.F. TO CENTE
	CEILING MOUNT VISUAL-ONLY NOTIFICATION DEVICE. CEILING MOUNT AUDIO-ONLY NOTIFICATION DEVICE. CEILING MOUNT AUDIO-VISUAL NOTIFICATION DEVICE. SMOKE DETECTOR WITH A 520MHZ SOUNDER BASE. CEILING MOUNT HEAT DETECTOR. DUCT SMOKE DETECTOR.	<u>SYMBOL</u>	DESCRIPTION VOICE/DATA OUTLET. MOUNT ADJACENT RECEPTACLE IF PR TO CENTER, UNLESS NOTED C OUTLET BOX TO NEAREST ACC SHALL BE 4 INCH SQUARE BY 2 NOTED OTHERWISE. "W" TEXT AT 56 INCHES A.F.F. TO CENTE OUTLET AT SAME HEIGHT, WIT
	CEILING MOUNT VISUAL-ONLY NOTIFICATION DEVICE. CEILING MOUNT AUDIO-ONLY NOTIFICATION DEVICE. CEILING MOUNT AUDIO-VISUAL NOTIFICATION DEVICE. SMOKE DETECTOR WITH A 520MHZ SOUNDER BASE. CEILING MOUNT HEAT DETECTOR. DUCT SMOKE DETECTOR. FIRE ALARM CONTROL PANEL.	<u>SYMBOL</u>	DESCRIPTION VOICE/DATA OUTLET. MOUNT ADJACENT RECEPTACLE IF PR TO CENTER, UNLESS NOTED C OUTLET BOX TO NEAREST ACC SHALL BE 4 INCH SQUARE BY 2 NOTED OTHERWISE. "W" TEXT AT 56 INCHES A.F.F. TO CENTE OUTLET AT SAME HEIGHT, WIT VIDEO MONITOR OUTLET. MOU ADJACENT RECEPTACLE). PRO ACCESSIBLE ATTIC SPACE. BU
	CEILING MOUNT VISUAL-ONLY NOTIFICATION DEVICE. CEILING MOUNT AUDIO-ONLY NOTIFICATION DEVICE. CEILING MOUNT AUDIO-VISUAL NOTIFICATION DEVICE. SMOKE DETECTOR WITH A 520MHZ SOUNDER BASE. CEILING MOUNT HEAT DETECTOR. DUCT SMOKE DETECTOR.	<u>SYMBOL</u>	DESCRIPTION VOICE/DATA OUTLET. MOUNT ADJACENT RECEPTACLE IF PR TO CENTER, UNLESS NOTED C OUTLET BOX TO NEAREST ACC SHALL BE 4 INCH SQUARE BY 2 NOTED OTHERWISE. "W" TEXT AT 56 INCHES A.F.F. TO CENTE OUTLET AT SAME HEIGHT, WIT VIDEO MONITOR OUTLET. MOU ADJACENT RECEPTACLE). PRO
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5V DUPLEX RECEPTACLE. MOUNT 18 INCHES ABOVE FINISHED FLOOR TED OTHERWISE.

5V DUPLEX RECEPTACLE. MOUNT 48 INCHES ABOVE FINISHED FLOOR BOVE COUNTER OR COUNTER BACKSPLASH TO CENTER, UNLESS

WITH 20A, 125V DUPLEX RECEPTACLE.

5V DOUBLE-DUPLEX RECEPTACLE. MOUNT 18 INCHES ABOVE R, UNLESS NOTED OTHERWISE

5V DOUBLE-DUPLEX RECEPTACLE. MOUNT 48 INCHES ABOVE ITER, OR 8 INCHES ABOVE COUNTER OR COUNTER BACKSPLASH TO HERWISE

X RECEPTACLE AS NOTED ON POWER PLANS.

250V RECEPTACLE. COORDINATE MOUNTING HEIGHT WITH NEMA TYPE AND CONFIGURATION TO MATCH EQUIPMENT BEING

20A, DUPLEX RECEPTACLE AND DATA OUTLET. PROVIDE WITH LOW

20A, DOUBLE-DUPLEX RECEPTACLE AND DATA OUTLET. PROVIDE

D FAULT CIRCUIT INTERRUPTER TYPE RECEPTACLE WHEN SHOWN SYMBOL ON PLANS.

ER RATED RECEPTACLE AND WEATHER-PROOF WHILE-IN-USE TYPE ADJACENT TO RECEPTACLE SYMBOL ON PLANS.

LL OUTLET CHARGER WITH 20A, 125V DUPLEX RECEPTACLE WHEN EPTACLE SYMBOL ON PLANS. PROVIDE GFCI AND WEATHER

ATION WHEN SHOWN ADJACENT TO DEVICE SYMBOLS ON PLANS. TA JACK AND RECEPTACLE AT 72" A.F.F., CENTERED ABOVE A DATA 18" A.F.F, UNLESS NOTED OTHERWISE

RCUIT NUMBERS WHEN SHOWN ADJACENT TO SYMBOLS ON PLAN.

INDICATES CIRCUIT SWITCHING ARRANGEMENT WHEN SHOWN MBOLS ON PLAN.

IOUNTING HEIGHT ABOVE FINISHED FLOOR TO CENTER OF OUTLET NT TO SYMBOLS ON PLAN.

X AS NOTED ON PLANS.

BOX AS NOTED ON PLANS.

) EYE.

N FOR ADA DOORS. MOUNTED AT ADA REQUIRED HEIGHTS.

WITCH. TEXT INDICATES AMP AND ENCLOSURE RATINGS.

CH. TEXT INDICATES AMP AND ENCLOSURE RATINGS.

ECT SWITCH COMBO. TEXT INDICATES AMP AND ENCLOSURE

SBARS INDICATE QUANTITY OF CONDUCTORS REQUIRED. MINIMUM INCH TRADE SIZE. MINIMUM CONDUCTOR SIZE SHALL BE #12 AWG.

BER OF ARROW HEADS INDICATES NUMBER OF CIRCUITS. PREFIX LATURE. NUMBERS INDICATE CIRCUIT NUMBERS.

GEND - TELCOM

NT OUTLET BOX AT 18 INCHES A.F.F. TO CENTER (EVEN WITH PRESENT) OR 8 INCHES ABOVE COUNTER OR COUNTER BACKSPLASH OTHERWISE. PROVIDE 1 INCH CONDUIT WITH PULLSTRING FROM CCESSIBLE CEILING CAVITY. BUSH CONDUIT ENDS. OUTLET BOX Y 2-3/4 INCH DEEP WITH A SINGLE GANG PLASTER RING, UNLESS KT ADJACENT TO SYMBOL DENOTES WALL PHONE LOCATION (MOUNT TER). WHERE SHOWN ADJACENT TO A POWER RECEPTACLE, INSTALL VITHIN 6 INCHES OF RECEPTACLE, UNLESS OTHERWISE NOTED.

IOUNT OUTLET BOX AT 18 INCHES A.F.F. TO CENTER (EVEN WITH ROVIDE 1 INCH CONDUIT FROM OUTLET BOX TO NEAREST BUSH CONDUIT ENDS. OUTLET BOX SHALL BE 4 INCH SQUARE BY 2-3/4 GANG PLASTER RING, UNLESS NOTED OTHERWISE.

IICATIONS OUTLET BOX FOR WIRELESS ACCESS POINT. OUTLET BOX H A SINGLE GANG PLASTER RING.

ELECTRICAL SPECIFICATIONS:

- ALL ELECTRICAL SYSTEMS SHALL BE INSTALLED IN ACCORDANCE WITH THE LATEST EDITION OF THE NATIONAL ELECTRIC CODE AND WITH ALL OTHER APPLICABLE STATE AND LOCAL CODES.
- UNLESS OTHERWISE NOTED, THE CONTRACTOR SHALL FURNISH AND INSTALL ALL MATERIAL AND EQUIPMENT AS INDICATED ON THE DRAWINGS. ALL MATERIALS AND EQUIPMENT SHALL BE NEW AND OF FIRST-CLASS CONSTRUCTION, AND SHALL BE THE PRODUCT OF AN ESTABLISHED AND REPUTABLE MANUFACTURER AND SHALL BE DESIGNED TO PERFORM THE SERVICE REQUIRED.
- ALL ELECTRICAL SYSTEMS SHALL BE INSTALLED IN STRICT ACCORDANCE WITH MANUFACTURER'S INSTALLATION INSTRUCTIONS. THE ENTIRE ELECTRICAL SYSTEM SHALL BE INSTALLED IN A NEAT AND WORKMANLIKE MANNER AND ACCORDING TO GOOD PRACTICE.
- ALL MATERIALS USED IN THE WORK SHALL BE APPROVED BY THE UNDERWRITER'S LABORATORIES, INC., AND SHALL BEAR THEIR LABEL WHERE SUCH APPROVAL IS AVAILABLE FOR THE TYPE OF MATERIAL
- THE CONTRACTOR SHALL, AT HIS 12. EXAMINE ALL ARCHITECTURAL, OWN EXPENSE, PROCURE ALL PERMITS, CERTIFICATES, AND LICENSES REQUIRED OF HIM BY LAW FOR THE EXECUTION OF HIS WORK.
- THE CONTRACTOR SHALL VISIT SITE TO OBTAIN KNOWLEDGE OF EXACT CIRCUIT DISTANCES AND INSTALLATION REQUIREMENTS.
- CONDUCTORS NO. 8 AND LARGER SHALL BE CODE GRADE THWN STRANDED COPPER WIRE. CONDUCTORS SMALLER THAN NO. 8 SHALL BE CODE GRADE THHN WIRE, SOLID OR STRANDED COPPER. MINIMUM WIRE SIZE SHALL BE NO. 12, UNLESS NOTED OTHERWISE.
- CONDUIT SHALL BE AS FOLLOWS: EMT OR MC CABLE SHALL BE USED FOR CONCEALED INTERIOR RACEWAYS AND ABOVE LAY-IN METAL CONDUIT WITH LIQUID TIGHT CONNECTIONS SHALL BE USED FOR ALL MECHANICAL EQUIPMENT CONNECTIONS, FLEXIBLE METALLIC (NON-LIQUID-TIGHT) CONDUIT SHALL BE USED FOR LAY-IN TYPE LIGHTING FIXTURES. CONDUIT SHALL BE 3/4" MINIMUM SIZE. THE USE OF CRIMP TIGHT CONNECTORS FOR CONDUIT WILL NOT BE ALLOWED. UNDERGROUND CONDUIT SHALL BE PVC EXCEPT AT CONDUIT BEND SHALL REMOVE FROM THE SITE

THROUGH FLOOR WHERE CONDUIT SHALL BE RIGID. ALL WORK PER NEC.

- DISCONNECT SWITCHES SHALL BE "HEAVY-DUTY" RATED. NEMA 1, 3R, OR 4X AS REQUIRED.
- 10. WIRING DEVICES (SWITCHES AND RECEPTACLES) SHALL BE 20A,125VAC "SPECIFICATION GRADE", WITH METAL DEVICE PLATE. SWITCH DEVICES SHALL BE HUBBELL 1221 OR APPROVED 17. ALL PENETRATIONS THROUGH EQUAL BY BRYANT, ARROW-HART, OR PASS AND SEYMOUR. RECEPTACLES SHALL BE HUBBELL #5362 SERIES OR APPROVED EQUAL BY BRYANT, ARROW-HART, OR PASS AND SEYMOUR. UTILIZE 18. THE ELECTRICAL CONTRACTOR GFI WHERE INDICATED.
- 11. CONTRACTOR SHALL PROVIDE SHOP DRAWINGS PER ARCHITECTURAL FRONT END DOCUMENTS ON ALL ELECTRICAL EQUIPMENT EQUIPMENT INCLUDING (BUT NOT LIMITED TO) LIGHT FIXTURES, SWITCHGEAR/PANELBOARDS, WIRING DEVICES, DATA/VOICE CABLING, DISCONNECT SWITCHES/CONTACTORS/TIME CLOCK, MOTION SENSORS, TRANSFORMERS AND DATA/TELEPHONE SUPPORT SYSTEMS.
- STRUCTURAL, PLUMBING AND HVAC CONSTRUCTION DRAWINGS. COOPERATE WITH OTHER TRADES IN LOCATING COMPONENTS IN ORDER TO AVOID CONFLICT WITH OTHER TRADE'S WORK. NO CLAIM FOR COSTS WILL BE ALLOWED FOR RELOCATING EQUIPMENT, ETC. THAT INTERFERES WITH OTHER TRADES WORK.
- 13. IN ADDITION TO EQUIPMENT GUARANTEE PROVIDED BY MANUFACTURER, THE CONTRACTOR SHALL FURNISH OWNER A WRITTEN GUARANTEE AGAINST DEFECT IN ALL MATERIALS AND WORKMANSHIP FOR A PERIOD OF ONE YEAR FROM DATE OF ACCEPTANCE OF WORK. DURING GUARANTEE PERIOD AND WITHOUT EXPENSE TO THE OWNER, REPAIR ALL DEFECTS IN WORKMANSHIP OR MATERIAL PROVIDED.
- CEILINGS. LIQUID TIGHT FLEXIBLE 14. DRAWINGS ARE DIAGRAMMATIC AND INDICATE THE GENERAL ARRANGEMENT OF ELECTRICAL INSTALLATION. THE EXACT LOCATION AND / OR ROUTING OF CONDUIT, RECEPTACLES, PANELS ETC., SHALL BE DETERMINED IN THE FIELD. MAKE REASONABLE MODIFICATIONS IN THE INSTALLATION AS REQUIRED BASED ON FIELD CONDITIONS.

15. AT THE COMPLETION OF THE PROJECT, THE CONTRACTOR AND DISPOSE OF ALL RUBBISH AND DISCARDED MATERIALS.


- 16. THE ELECTRICAL CONTRACTOR SHALL KEEP ACCURATE RECOR OF INSTALLATION THAT DEVIAT FROM THE DRAWINGS. AT THE COMPLETION OF PROJECT, CONTRACTOR SHALL PRESENT THE OWNER A MARKED UP SET AS BUILT PRINTS WITH INDICAT CHANGES.
- WALLS AND FLOORS SHALL BE PROVIDED WITH PROPERLY SIZ SLEEVES. SEAL ALL SLEEVES V APPROPRIATE CAULK.
- SHALL PROVIDE TRAINING TO OWNER ON ALL ELECTRICAL EQUIPMENT.
- 19. CIRCUIT BREAKER PANELBOAR SHALL HAVE AIC RATING AS INDICATED ON BUSSING DIAGR PANELBOARDS SHALL BE SQUA D OR APPROVED EQUAL BY GE CUTLER HAMMER, OR SIEMENS CONTRACTOR SHALL PROVIDE DETAILED TYPED PANELBOARD DIRECTORY.
- 20. ALL HVAC, PLUMBING AND ELECTRICAL EQUIPMENT, PIPE DUCTWORK, CONDUIT, ETC. SH **BE RESTRAINED TO RESIST** SEISMIC FORCES. RESTRAINT SHALL MAINTAIN EQUIPMENT, PIPING, DUCTWORK AND CONDUIT IN A CAPTIVE POSITION. RESTRAINT DEVICES SHALL BE DESIGNED AND SELECTED TO MEET THE SEISMIC **REQUIREMENTS AS DEFINED IN** THE LATEST ISSUE OF THE KENTUCKY BUILDING CODE OR LOCAL JURISDICTION BUILDING CODE.
- 21. EC SHALL BE RESPONSIBLE FOR LOW VOLTAGE DATA BACKBOX, CONDUIT, AND PULL STRING UNLESS NOTED OTHERWISE.
- 22. FIRE ALARM DESIGN IS FOR INTENT PURPOSES ONLY. ALL DEVICES, PANELS, ETC. SHALL BE IN ACCORDANCE WITH ALL APPLICABLE CODES AND STANDARDS.
- 23. FIRE ALARM CONTRACTOR SHALL SUBMIT FULLY DESIGNED FIRE ALARM DRAWINGS TO AHJ FOR COMPLETE REVIEW.
- 24. DUCT SMOKE DETECTORS SHALL BE PROVIDED FOR ALL HVAC UNITS SUPPLYING 2000 CFM OR GREATER.
- 25. EC SHALL BE RESPONSIBLE FOR UPSIZING CONDUCTOR SIZING AS REQURIED TO ACHIEVE A VOLTAGE DROP OF LESS THAN 5% ON BRANCH CIRCUITS.

CKT #	CIRCUIT NAME	BREAKER SIZE	FEEDER SIZE	Α	В	CKT #	CIRCUIT NAME	BREAKER SIZE	FEEDER SIZE
1	CU-1	35A/2	2#8, 1#8 G, 1"C	7968		2	CU-1	35A/2	2#8, 1#8 G, 1"C
3					7968	4			
5	FITNESS AREA DEDICATED REC.	20A/1	2#12, 1#12 G, 3/4"C	2280		6	BUNKS 1 & 2	20A/1	2#12, 1#12 G, 3/4"C
7	FITNESS AREA DEDICATED REC.	20A/1	2#12, 1#12 G, 3/4"C		2280	8	BUNKS 3 & 4	20A/1	2#12, 1#12 G, 3/4"C
9	FITNESS AREA DEDICATED REC.	20A/1	2#12, 1#12 G, 3/4"C	2460		10	BUNKS 6 & 7	20A/1	2#12, 1#12 G, 3/4"C
11	FITNESS AREA DEDICATED REC.	20A/1	2#12, 1#12 G, 3/4"C		2280	12	BUNKS 8 & 9	20A/1	2#12, 1#12 G, 3/4"C
13	FITNESS AREA TV	20A/1	2#12, 1#12 G, 3/4"C	1440		14	BUNKS 5 & 10	20A/1	2#12, 1#12 G, 3/4"C
15	FITNESS AREA TV	20A/1	2#12, 1#12 G, 3/4"C		900	16	CORRIDOR REC.	20A/1	2#12, 1#12 G, 3/4"C
17	WH	20A/2	2#12, 1#12 G, 3/4"C	1600		18	BEDROOM LIGHTING	20A/1	2#12, 1#12 G, 3/4"C
19					1500	20	CORRIDOR, EXERCISE LIGHTING	20A/1	2#12, 1#12 G, 3/4"C
21	CLOTHES DRYER	30A/2	2#10, 1#10 G, 3/4"C	2500		22	SPARE	20A/1	
23					4000	24	CLOTHES WASHER	20A/1	2#12, 1#12 G, 3/4"C
			Total Load (KVA)	18.25	18.93				
			Total Load (A)	152.0667	157.7333	1			

	GENERAL NOTES:	
4	 ALL WORK SHALL BE DONE BY A LICENSED CONTRACTOR. 	
PR PRDS TED E	 THE CONTRACTOR SHALL BE RESPONSIBLE FOR JOBSITE SAFETY, INCLUDING REQUIREMENTS OF AUTHORITIES HAVING JURISDICTION. ALL CONSTRUCTION DEBRIS SHALL BE DISPOSED OF BY THE CONTRACTOR, UNLESS NOTES 	
T TO T OF TED	OTHERWISE. 4. THERE SHALL BE NOTHING ABANDONED IN PLACE, UNLESS SPECIFICALLY IDENTIFIED AS SUCH. 5. ALL WORK SHALL COMPLY WITH THE	
1	REQUIREMENTS OF THE CONTRACT DOCUMENTS, INCLUDING ADDENDA, AND APPLICABLE CODES AND STANDARDS.	
E ZED WITH	 ALL TRADES SHALL COORDINATE THE ROUTING AND INSTALLATION OF HIS WORK WITH THAT OF ALL OTHER TRADES THROUGH THE GENERAL CONTRACTOR. 	
PR THE	7. PROVIDE ALL EQUIPMENT, MATERIAL, LABOR, SUPERVISION, COST, AND SERVICES REQUIRED TO INSTALL COMPLETE AND WORKING SYSTEMS. INCLUDING ALL ITEMS AND APPURTENANCES NECESSARY, REASONABLE, INCIDENTAL, OR	
RDS	CUSTOMARILY INCLUDED, EVEN THOUGH EACH AND EVERY ITEM IS NOT SPECIFIED OR SHOWN.	
RAM. ARE	8. ALL ELECTRICAL WORK SHALL BE IN ACCORDANCE WITH WITH ALL APPLICABLE STATE AND LOCAL BUILDING CODES, INCLUDING THE NEC.	
=, S. =	9. ALL ELECTRICAL EQUIPMENT INSTALLED SHALL MEET MANUFACTURER SPECIFICATIONS.	
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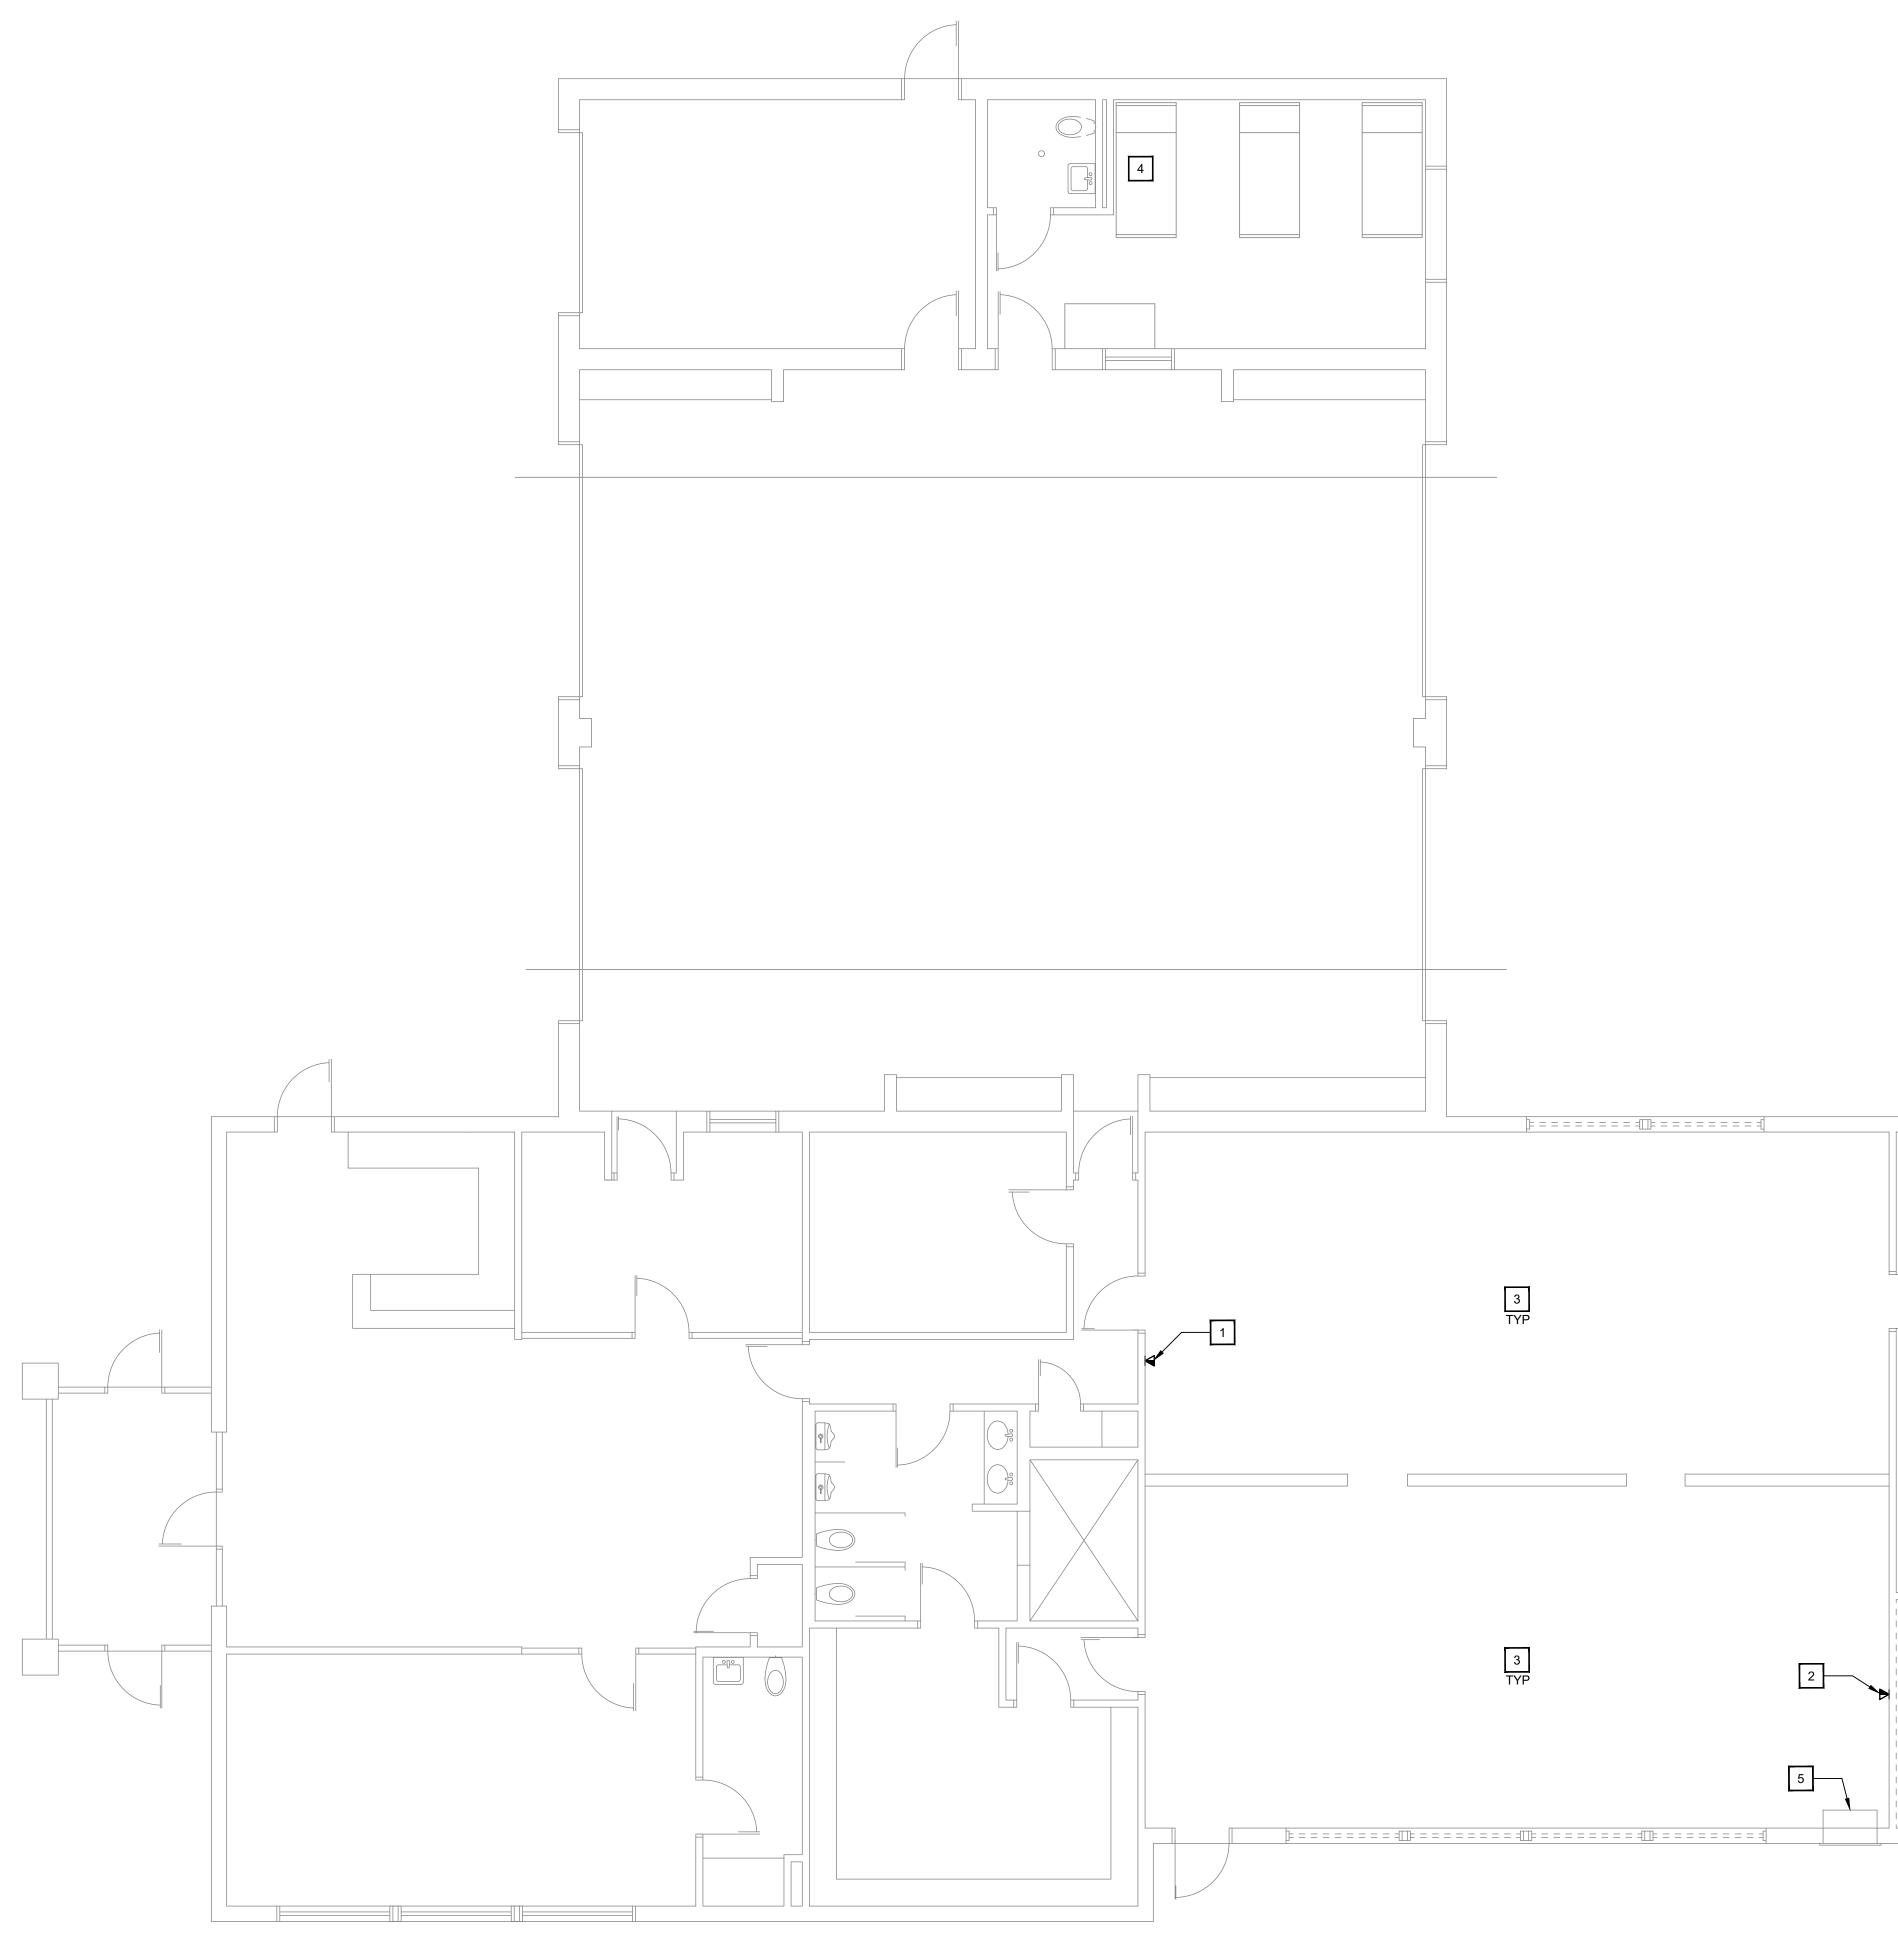
1830 DESTINY LANE, SUITE 113 BOWLING GREEN, KY (270) 599-0182 ACT JUSTLY, LOVE MERCY, WALK HUMBLY






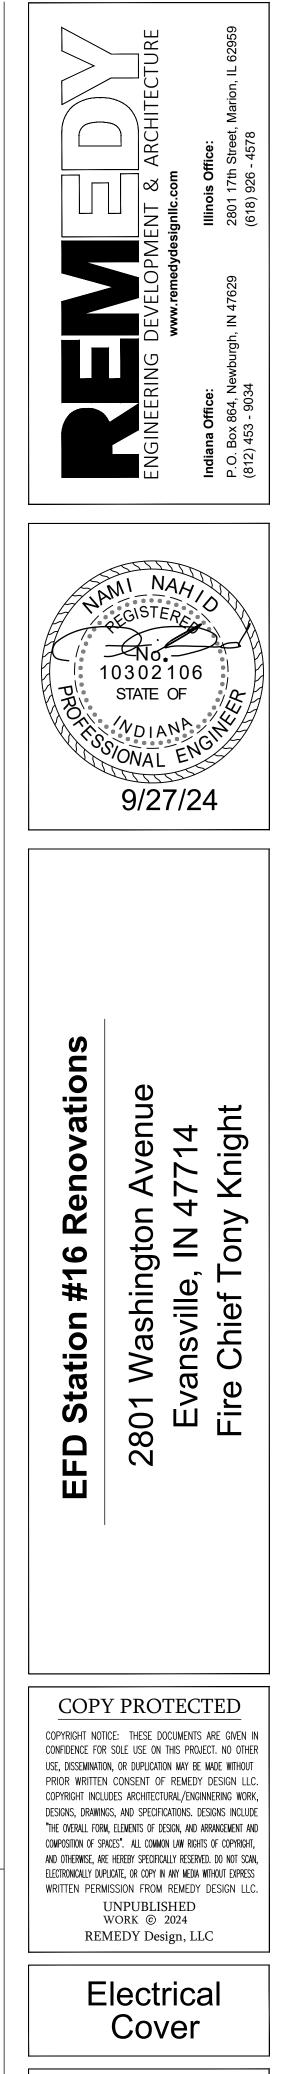





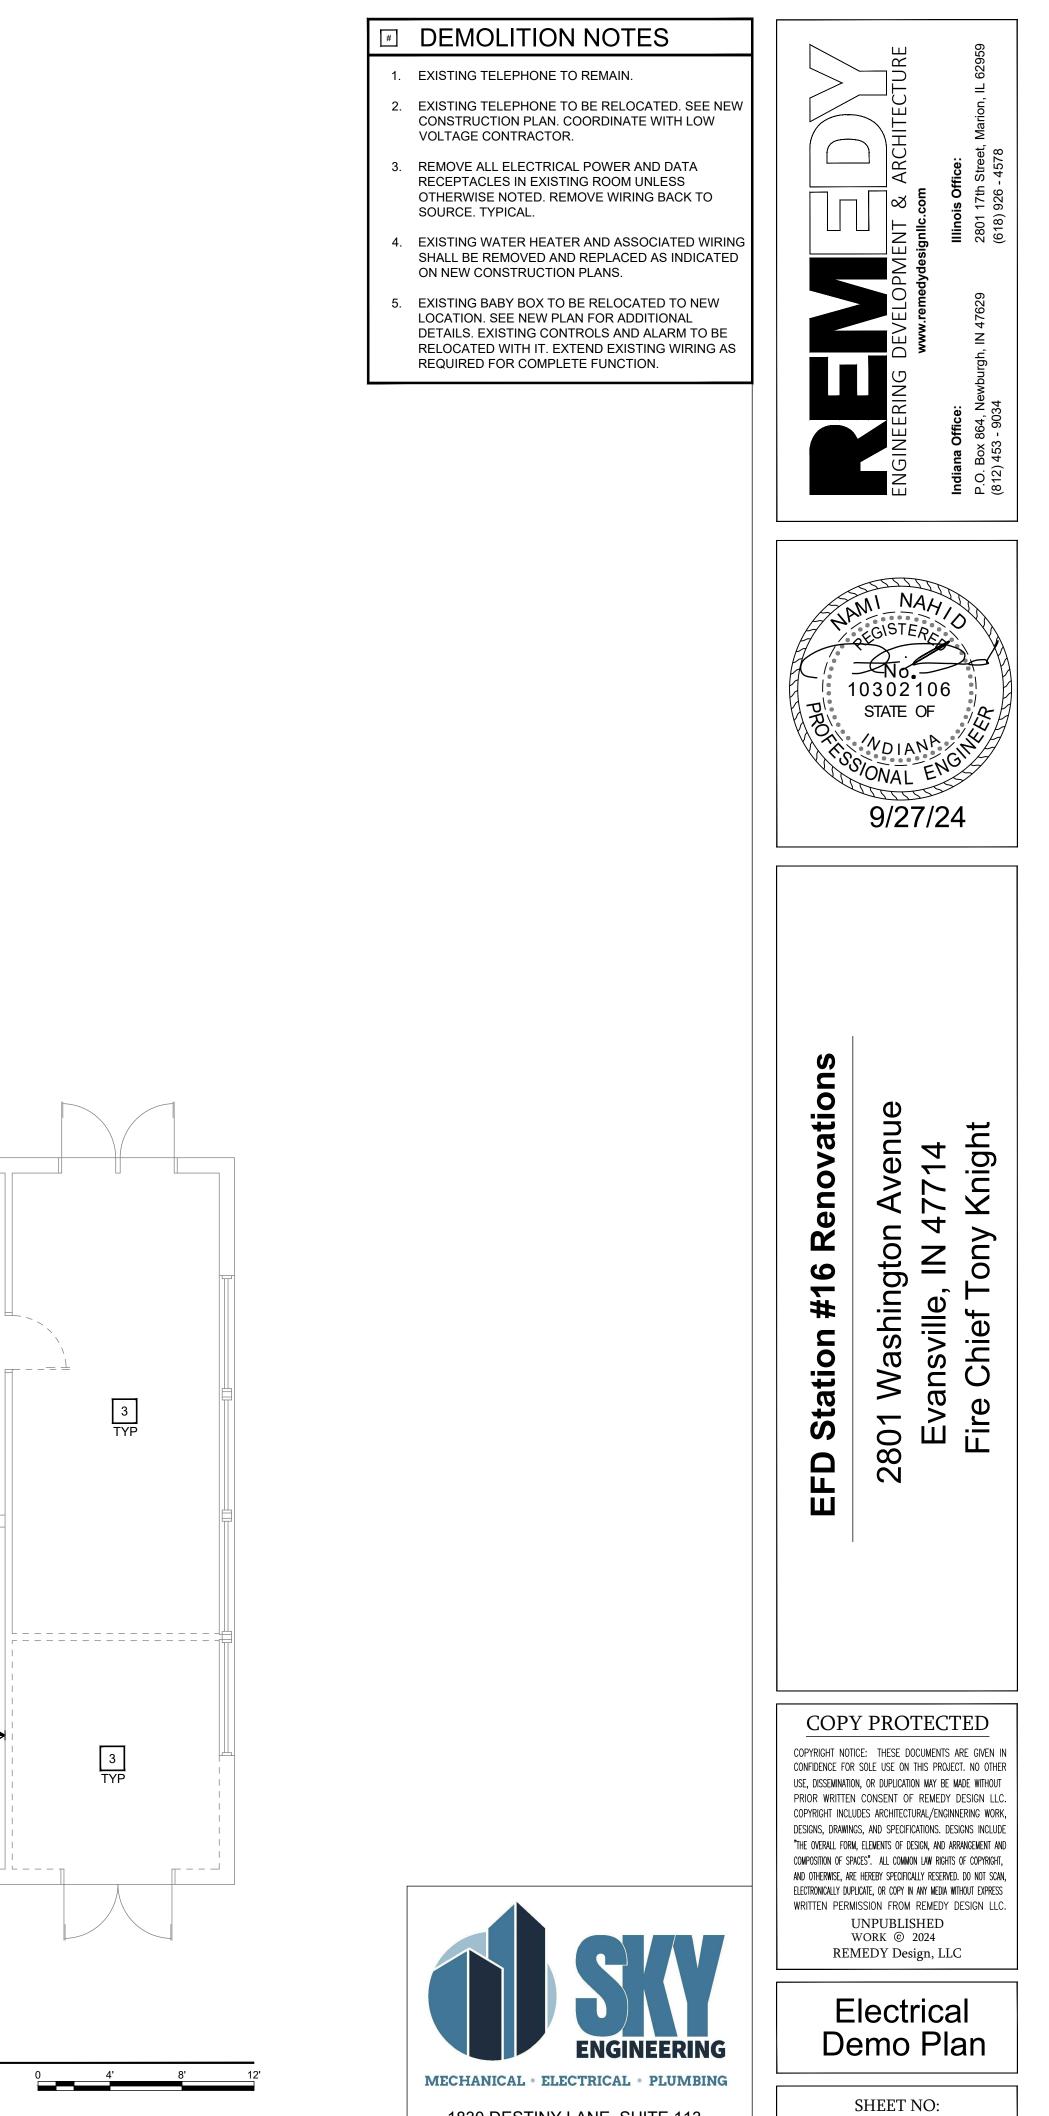


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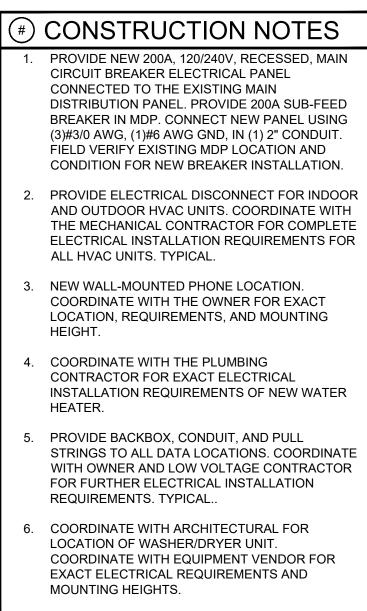
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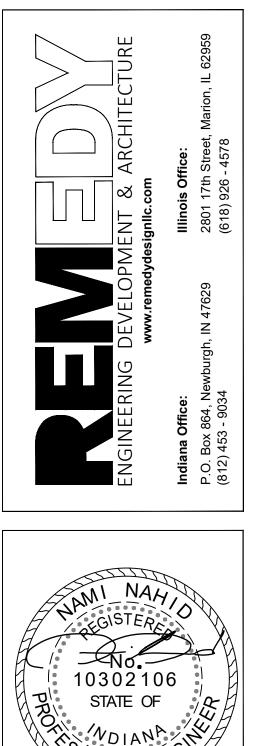
1830 DESTINY LANE, SUITE 113 BOWLING GREEN, KY (270) 599-0182 ACT JUSTLY, LOVE MERCY, WALK HUMBLY

E-1.0





7. EXISTING BABY BOX TO BE RELOCATED IN ENTIRETY. DISCONNECT FROM EXISTING CONTROLS AND ALARM SYSTEM. RELOCATE TO NEW LOCATION AS INDICATED. PROVIDE NEW DEDICATED 120V, 20A CIRCUIT WITH BREAKER FOR NEW OUTLET.

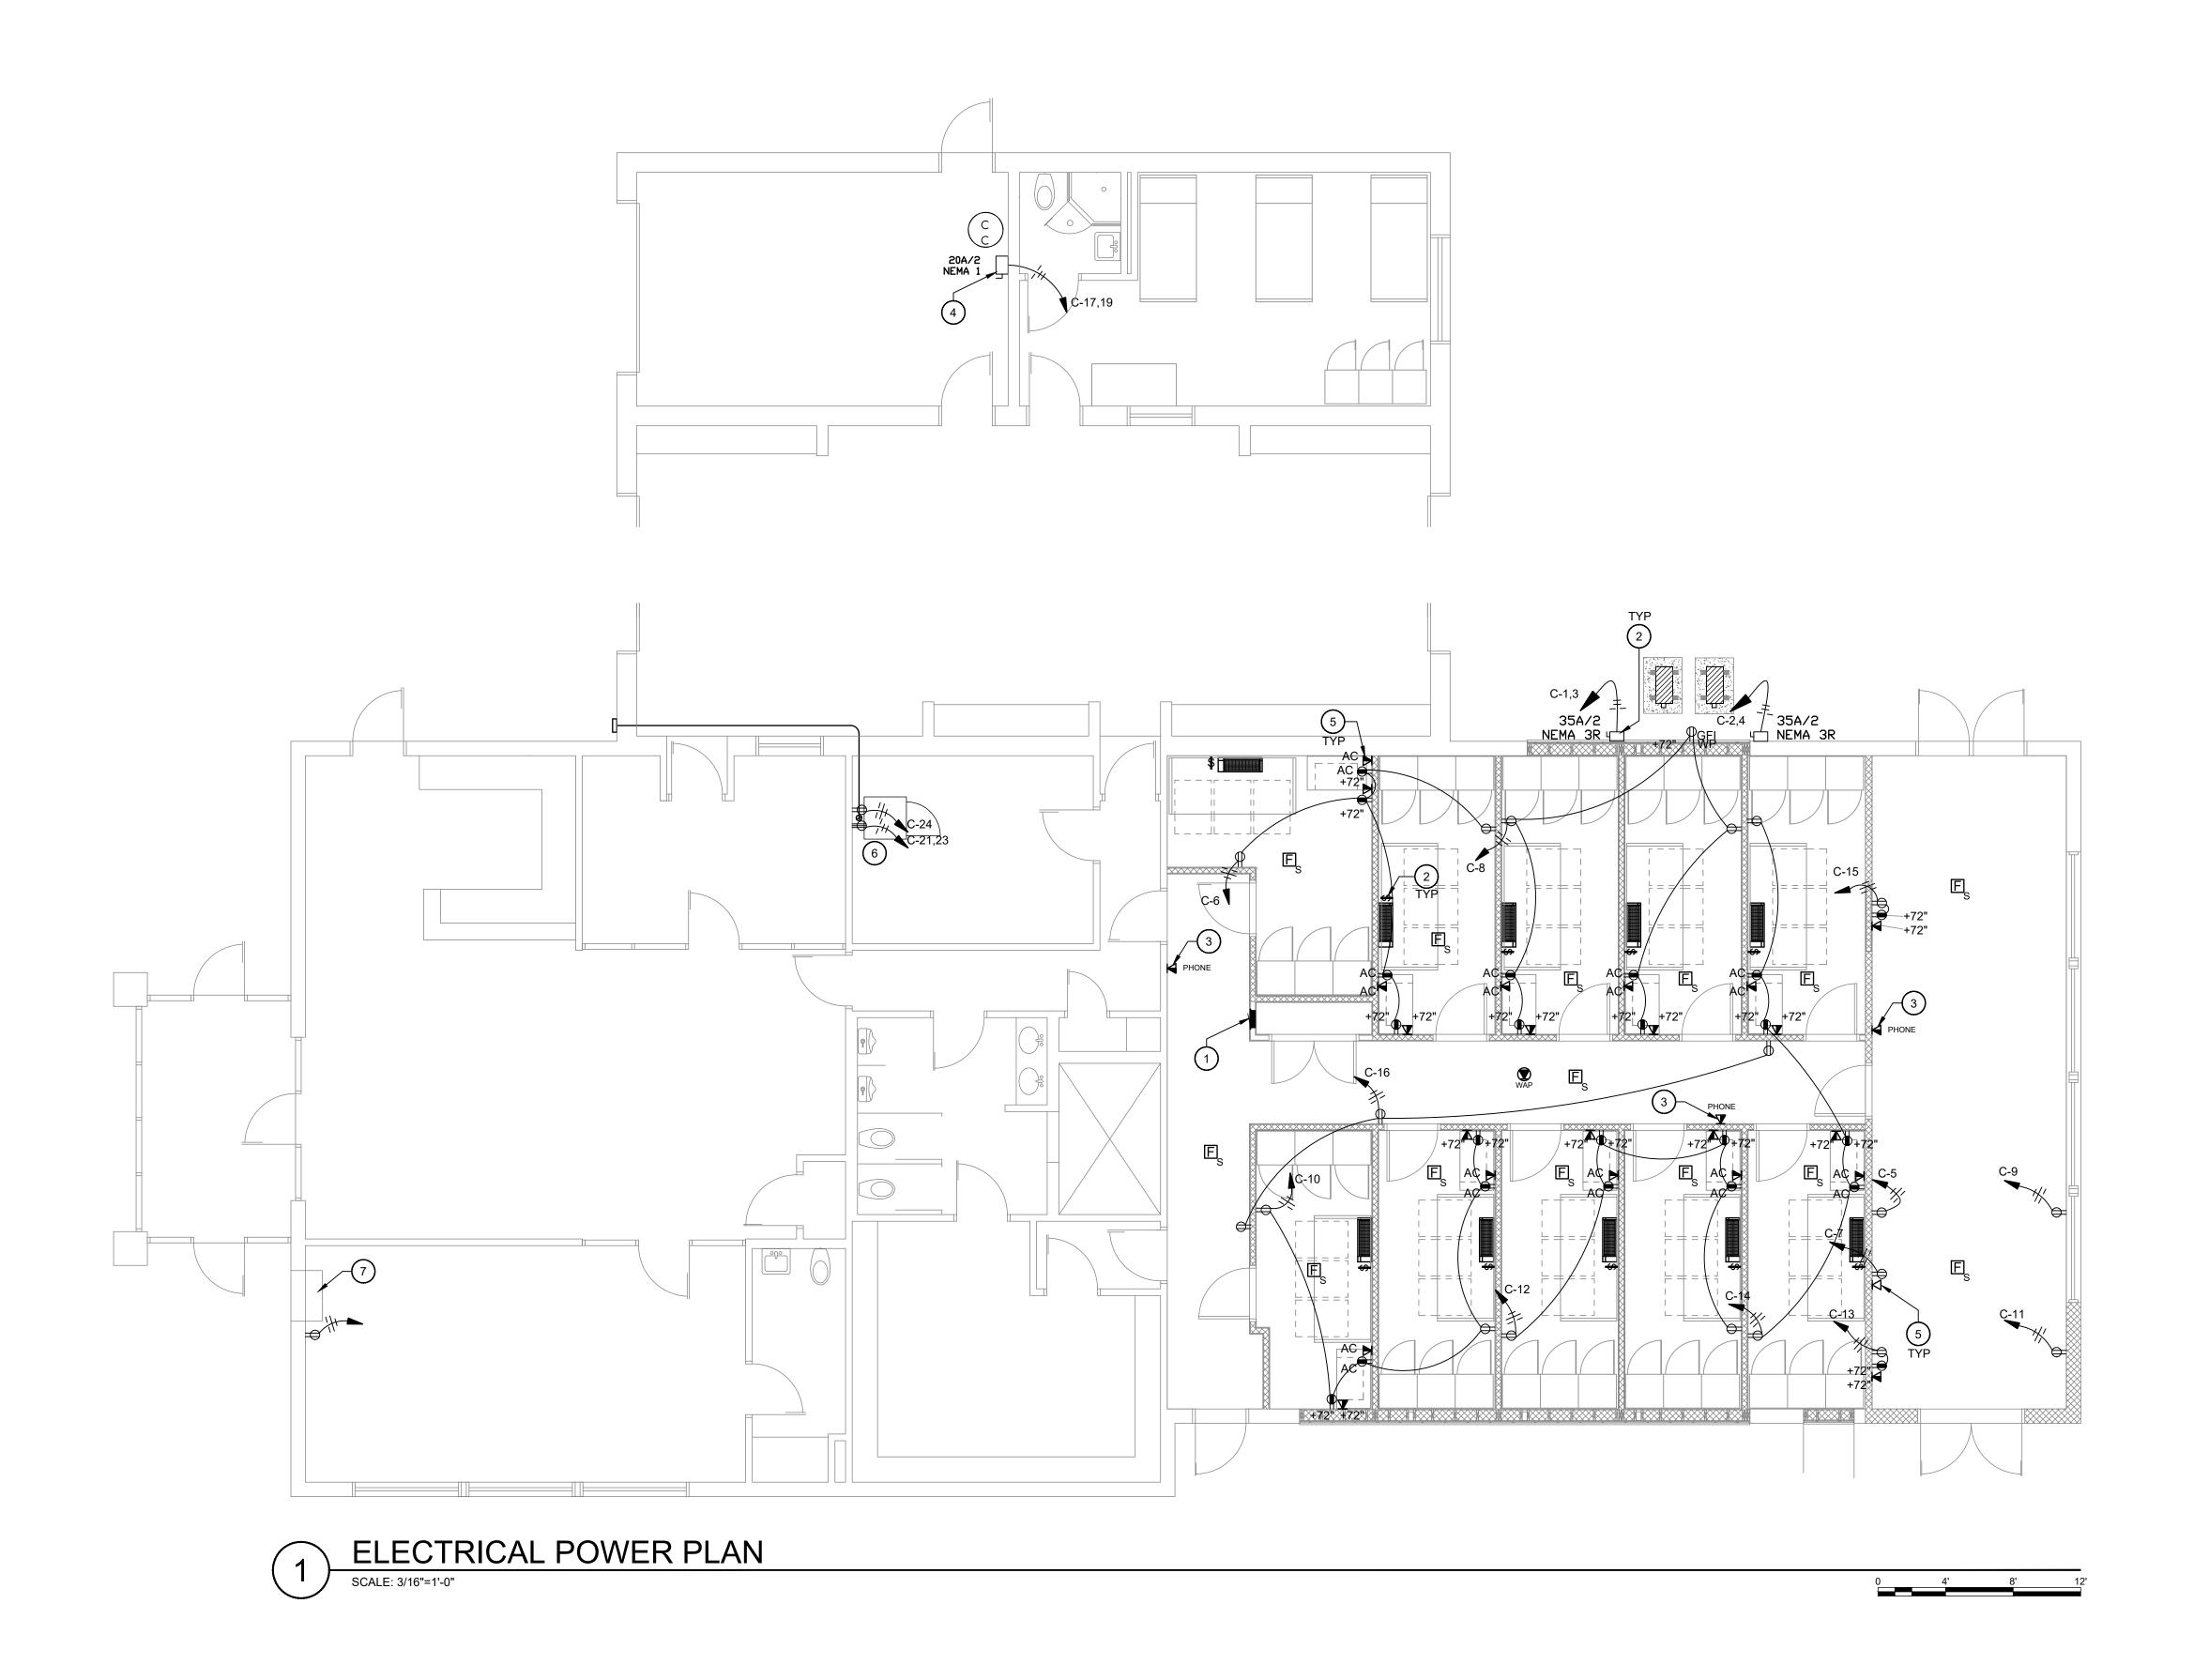

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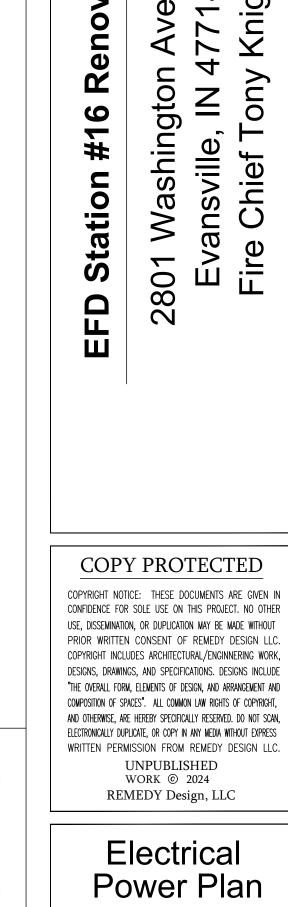
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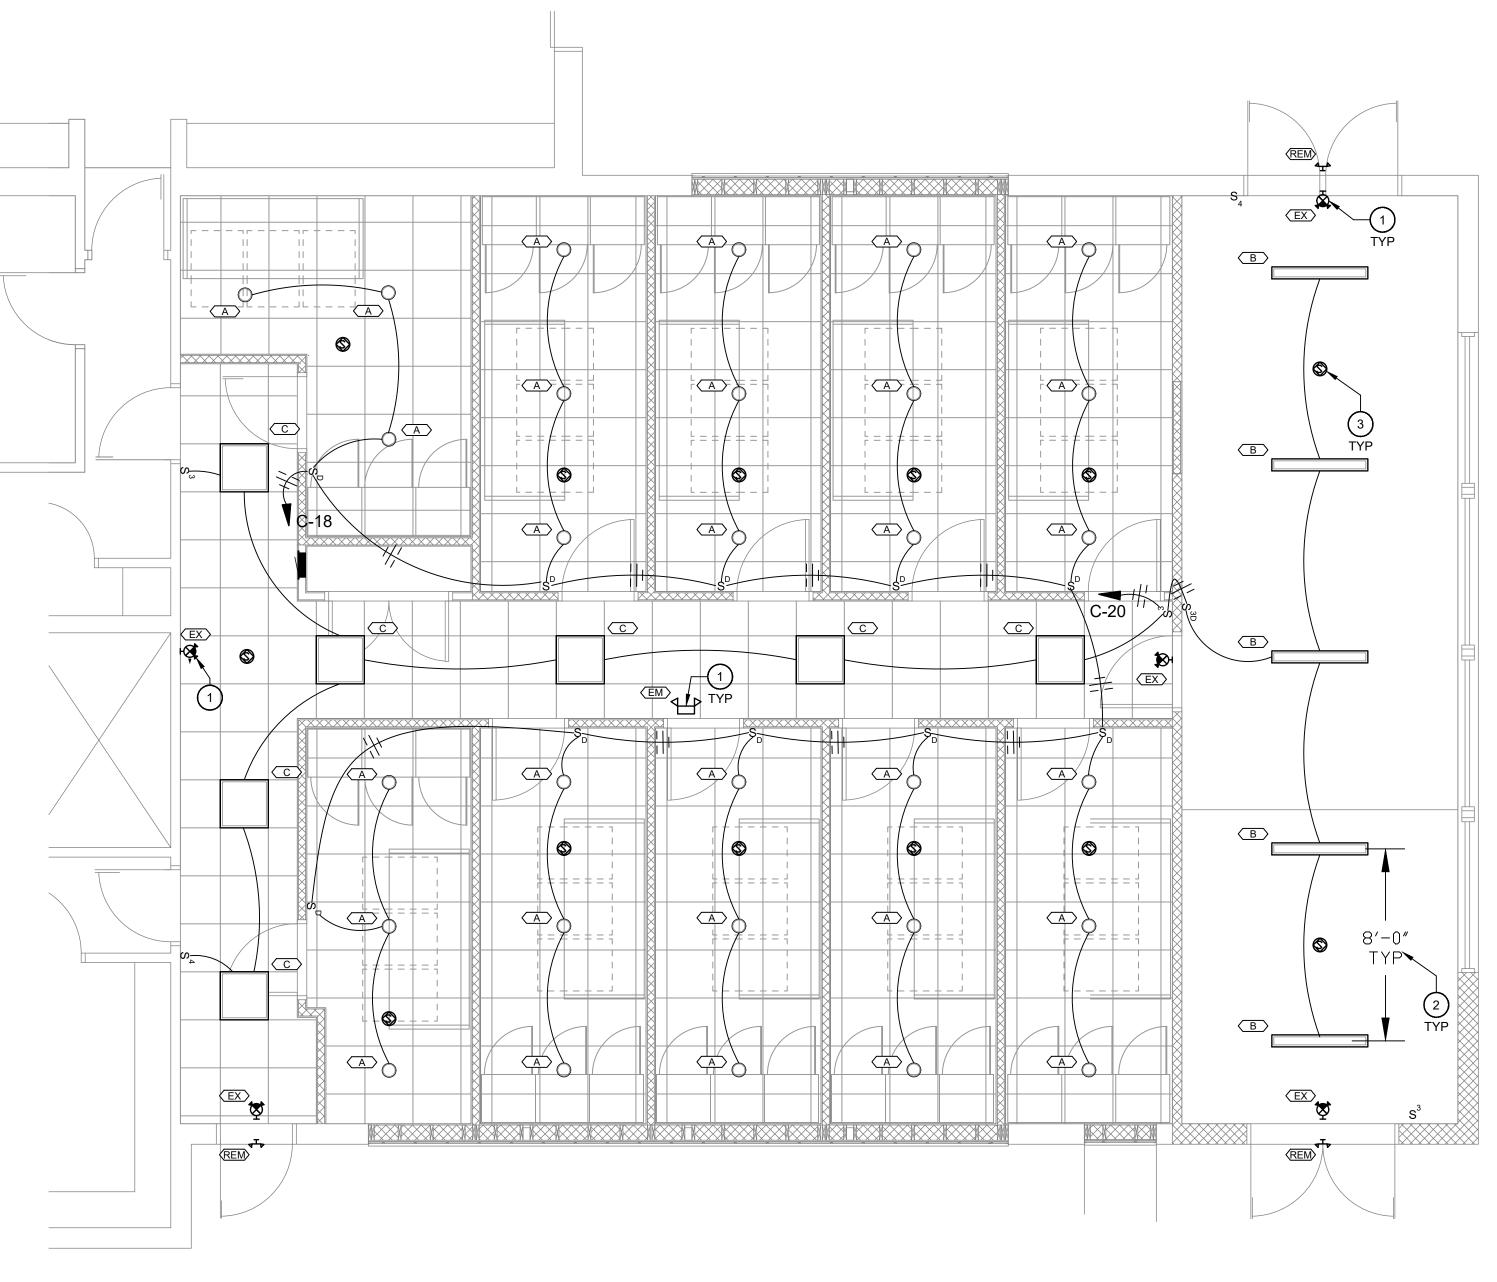
SHEET NO:



1830 DESTINY LANE, SUITE 113 BOWLING GREEN, KY (270) 599-0182 ACT JUSTLY, LOVE MERCY, WALK HUMBLY

E-1.1





	LIGHTING & CEILING SCHEDULE											
TAG	DESCRIPTION	MANUFACTURER	SERIES	LUMENS	ССТ	CRI	LM	HOURS	WATTS	VOLTAGE	MOUNTING	
А	6" SWITCHABLE DOWNLIGHT WAFER	JUNO	WF6	990	3,500	90	70	50,000	13	120V	RECESSED/ CEILING	
В	LOW PROFILE LED WRAPAROUND	LITHONIA	BLWP4	4,800	3,500	82	80	60,000	48	120-277V	SURFACE/ CEILING	BI
С	2'X2' LED FLAT PANEL	LITHONIA	СРХ	2,500	3500	80	70	50,000	19	120-277V	RECESSED/ GRID	CPX 2X2
EM	EMERGENCY LIGHT	LITHONIA	ELM4	-	-	-	-	-	3	120/277V	SURFACE/ WALL	
EX	EXIT FIXTURE	LITHONIA	LHQM	-	-	-	-	-	2.5	120/277V	SURFACE/ WALL	
REM	EXTERIOR REMOTE HEAD	LITHONIA	ELA	_	-	_	_	-	2	9.6V	SURFACE/ WALL	

SCHEDULE NOTES:

1. FIXTURE SCHEDULE IS USED FOR BASIS OF DESIGN. ANY PROPOSED FIXTURE EQUIVALENTS TO BE APPROVED ONLY BY ENGINEER PRIOR TO BID. FIXTURES SUBMITTED AS PROPOSED EQUAL SHALL CONTAIN ORIGINAL SPECIFIED FIXTURE CUTSHEET ALONG WITH PROPOSED EQUIVALENT FIXTURE SHOWING PHOTOMETRIC DATA AND EFFICIENCY DATA. 2. LIGHTING FIXTURE SCHEDULED OR AN ENGINEER APPROVED EQUIVALENT SHALL BE INSTALLED.

3. FINAL FINISHES SHALL BE SELECTED BY ARCHITECT.

4. MOUNTING HARDWARE AND ACCESSORIES SHALL BE ACQUIRED FOR EACH FIXTURE AND SHALL BE SUITABLE FOR THE MOUNTING APPLICATION AND THE ENVIRONMENT IN WHICH THE FIXTURE IS TO BE INSTALLED.

ELECTRICAL LIGHTING PLAN

1

SCALE: 1/4"=1'-0"

REMARKS

WF6 SWW5 90CRI

BLWP4 48L GZ10 LP835

2X2 ALO7 80CRI SWW7 MVOLT

ELM4L

LHQM HO

ELA SD

(#) CONSTRUCTION NOTES EMERGENCY AND EGRESS LIGHTING SHALL BE CONNECTED TO AN UNSWITCHED HOT CONDUCTOR. CONNECT TO THE NEAREST LIGHTING CIRCUIT. TYPICAL OF ALL EMERGENCY AND EGRESS FIXTURES.

- 2. TYPICAL FIXTURE SPACING FOR SIMILAR FIXTURES IN SIMILAR SPACES. TYPICAL.
- 3. COORDINATE WITH THE LOW VOLTAGE CONTRACTOR FOR INSTALLATION REQUIREMENTS FOR NEW SPEAKERS ON EXISTING SPEAKER SYSTEM. TYPICAL OF ALL NEW SPEAKER LOCATIONS.





*r*ations nue Knight 4 Avei 7714 #16 Renov 2801 Washington / Evansville, IN 47 Fire Chief Tony / 4 **EFD** Station

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Electrical Lighting Plan



ACT JUSTLY, LOVE MERCY, WALK HUMBLY

